

FINANCIAL ASSISTANCE FOR MINERAL EXPLORATION (M.E.I.G.A.)

COMPANY: CONSOLIDATED GOLDFIELDS LTD

REF: AE 3

PROJECT: SCOTLAND AND N. ENGLAND MOLYBDENITE STUDY

MRD 84/2/4 & 8

MRD 144/2/4

The following Open File material is held by B.G.S. in London, Keyworth, Newcastle and Edinburgh. Available for public inspection from 23.11.86.

- OS sheet 2 showing location of Assynt, South Harris, Scourie.
1": 4 miles.
- * Extracts from application 30.7.71:
"Outline of proposed project geological considerations work programme" with the following overlays:
 - (a) No.2, 1": 10 miles Areas of interest of G.B. sheet 1.
25.6.71. Scotland and N. England Mo and other metals
 - (b) No.3, 1": 1 mile Geological Survey, sheet 23, of the Cockermouth area 28.7.71
 - (c) No.4. 1": 1 mile. O.S. Sheet 90. Gassington Area
- * Extract "Copper Nickel and Molybdenite projects" from CGF letter dated 13.8.71
- Extract from Supplementary Application 5.6.72 "outline of project and geological considerations"
- Letter from CGF dated 5.6.72 (RE: merger of AE2 and 3)
- " " " 30.6.72 " " " "
- Technical report 2.8.71 to 5.6.72 by E.M. Jones (submitted with application 30.5.74 (AE3)) with negatives 1 to 43 of the following:

Talnotry and Creetown

1. Creetown, reconnaissance stream sediment results Copper/Molybdenum/Tin/Tungsten.
2. Talnotry Forests, reconnaissance stream sediment results Copper/Molybdenum
3. Talnotry Forests (Part): reconnaissance stream sediment results, Nickel
4. Talnotry Molybdenum Areas - Little water of Fleet: soil sampling Molybdenum
5. Talnotry Molybdenum Areas - Loch Ken: soil sampling Molybdenum results

. . . . (continued)

6. Talnotry Molybdenum Areas - Craiglowrie: soil sampling
Molybdenum results
7. Talnotry Mine Area - reconnaissance soil sampling Copper/Nickel
8. Talnotry Mine Area - vertical magnetic intensity, reconnaissance
survey
9. Talnotry Mine Area - detail soil sampling Copper/Nickel
10. Talnotry Mine - Vertical magnetic intensity, detailed survey

Cockermouth

11. Reconnaissance stream sediment sampling, Cu, Pb, Zn,
 $2\frac{1}{2}''$: 1 mile. May '71
12. Reconnaissance soil sampling results: Copper NY13NE, NY23NW.
 $6''$: mile. April '72
13. " " " " " " Lead and zinc, NY13NE,
NY23NW. $6''$: 1 mile.
April '72
- * 14. " " I.P. Chargeability values
- * 15. " " I.P. Resistivity values
- * 16. " " I.P. Gradient Array chargeability values
17. Pit profiles and Geochemical profiles Copper, Lead, Zinc,
Mercury. $6''$: 1 mile. May '72
- # 18. Detailed soil profile sampling, Cu, Pb, Zn. $25''$: 1 mile.
Oct '72
- # 19. Section, lines C-K, Cu, 2 cm = 100'. Oct '72
- # 20. " " " Pb, " " "
- # 21. " " " Zn, " " "
- # 22. Detailed IP chargeability values. $25''$: 1 mile. Oct '72.
Extended Dec '72
- # 23. Resistivity values. $25''$: 1 mile. Oct '72. Extended Dec '72

. . . . (continued)

Dalbeattie

24. Reconnaissance stream sediment sampling results. Copper, Molybdenum, Tin, Tungsten
25. Aireland Moor soil sampling results - Molybdenum
26. " " " " " - Copper
27. Barclesh Hill " " " - Molybdenum
28. " " " " " - Copper
29. Rascarrell soil sampling results - Copper
30. Barcloy - Whitehills soil sampling results - Copper
31. " " " " " " - Molybdenum
32. Colvend, detail soil sampling - Copper
33. Cushat Wood - Airdrie farm Follow up stream sediment results Copper, Lead, Zinc

Mullach

34. Reconnaissance stream sediment sampling results, Copper, Molybdenum
35. Follow-up stream sediment sampling results, Copper, Molybdenum
36. Soil sampling results, Copper, Molybdenum

Clerich (Aviemore)

37. Reconnaissance stream sediment sampling results, Copper, Molybdenum
38. Alvie Estate; soil sampling results, Copper, Molybdenum
39. " " " " " Molybdenum
40. Kinreachy Estate; soil sampling results and follow-up stream sediment results, Copper/Molybdenum
41. Kinreachy Estate; soil sampling. South extension of grid. Sample location Copper/Molybdenum

. . . . (continued)

Fearn

42. Reconnaissance stream sediment sampling results, Copper, Molybdenum

43. Follow-up stream sediment sampling results

- Report dating 6.6.72 to 30.6.73, extended to 31.3.74 (AE3/2) by EMJ with enclosure Fig 6. Talnotry Molybdenum areas soil sampling Cu/Mo results
- Extract from second supplementary application 3.4.74 ".... outline of project work programme"
- * Letter from company dated 7.11.75. Re claim 3/3
- Report by E.M. Jones 7.11.75 on Assynt with the following enclosures:
 - Figs 1 to 12. Geology and Rock sample locations, 6" : 1 mile, July 1974
 - Figs 13 and 14. Stream sediment results, 1 : 63360, OS map 13
 - Fig 15. Soil grid results
 - Figs 16-17. Reconnaissance magnetometry survey
 - Fig 18. Follow-up soil sampling
 - Fig 19. IP resistivity
 - Fig 20. Chargeability
 - Fig 21. Metal factor
 - Fig 22. Magnetometer survey
- Table 1. Rock assay results

. . . . (continued)

- Report by E.M. Jones, 7.11.75 on South Harris, with the following enclosures:

Fig 1. Soil sample results, Copper, Nickel, Zinc

Fig 2. Rock sample results, Copper, Nickel, Zinc

Table 1. Rock samples. Petrology results

- Report by E.M. Jones 7.11.75 on Scourie with the following enclosures:

§# 1 Reconnaissance stream sample results, Cu, Ni, Zn,
1": 1 mile

§# 2 Soil and stream sediment results, Zn 6": 1 mile

§# 3 " " " " " "

§# 4 " " " " " "

§# 5 " " " " " "

§# 6 " " " " " "

§# 7 I.P. apparent resistivity, 1 : 2,500

§# 8 I.P. chargeability, 1 : 2,500

§# 9 I.P. metal factor, 1 : 2,500

§# 10 Magnetometer survey (based on I.P. grid) 1 : 2,500

§# 11 Soil sampling results; Cu, Pb, Ni, Zn, 1 : 2,500

- * Letter from CGF dated 17.5.76 enclosing the rock descriptions, PSE series, for the Scourie samples PSR 1 to 44
- Extracts (1 to 8 inc) from 3rd supplementary application 12.11.75 with enclosures 1 to 8
 1. Part of OS sheet no. 9, 1": 1 mile
 2. Part of sheet NC24 NW, 6": 1 mile
 3. IP chargeability map, 1 : 2500
 4. IP resistivity map, 1 : 2500
 5. E.M. map, Scourie area
 6. E.M. imaginary component, high frequency Scourie
 7. IP profiles, Scourie
 8. IP profiles, Foindle

Technical Report for 24.11.75 to 1.6.76 (stage 4), with enclosures:

Figs 1 and 2, Drill sites SBH 1 to 5, 1 : 2500, OSNC14NE, 17.3.76

Figs 3 to 6 Geophysical profiles, geological sections and sulphide content of core 1 cm = 25'. 7.3.76

Table 1. Precious metal analyses

Table 2. Multi-element spectrographic scan results

Appendix 1. Geological graphic and sulphide logs SBH 1 to 5

*# Appendix 2. Petrographic report

§# Estimated abundances of rock types of sulphides in boreholes
(2 tables)

Not in London * Not in Keyworth § Not in Edinburgh

AE 3 is closely related to AE 2 and AE 130

EMJ/RMS

20th March 1974

SCOTLAND AND NORTH OF ENGLAND MOLYBDENITE etc. ARE

Technical Report for period 2nd August 1971 - 5th June 1972

During the period geological reconnaissance and stream sediment surveys were undertaken in 16 areas. The results of this work caused many of the areas to be given up but 7 localities merited further investigation.

1. Reconnaissance Geochemistry

As the project had been underway for 6 months before the mineral incentive scheme became operative some of the reconnaissance geochemical surveys had already been carried out. Where follow-up work was undertaken however, non-qualifying reconnaissance results accompany this submission in order to complete the overall picture.

*Any areas not mentioned
are not given up*

Areas given up after the reconnaissance stage:-

Craven faults, Etive, Moy and Foyers,
Arran, Cluanie, Inchbae, Skelpick,
Scourie, Skye.

* Field checks were undertaken in some areas before the ground was relinquished, and in the case of Scourie and Skelpick further access was refused to the properties involved and it has not been possible to follow-up initially encouraging results. If access is obtained at a later date to either of these areas, then a separate grant application will be made to cover any work undertaken.

2. Follow-up Geochemistry and Geophysics

Further work was merited in the following areas, each of which is discussed individually.

Talnotry, Cockermouth, Dalbeattie, Creetown,
Mullach nan Coirean and Ballachullish, Clerich,
Fearn.

This work screened out all of the remaining areas apart from Cockermouth where a scout drilling target was located. The diamond drilling programme formed the basis of a separate grant application and this area has now been isolated under the Torpenhow project. The record of the work leading up to the drilling stage

has been included with this and the subsequent submissions.

2.1 Talnotry and Creetown

The reconnaissance of the Talnotry and Creetown areas located a series of molybdenum anomalies along the southern side of the Cairnsmore of Fleet granite, and the two areas were considered jointly for follow-up work. Low order copper anomalies on the northern side of the Fleet granite and along the southern margin of the Merrick granite were also checked. Soil geochemical and magnetic surveys were undertaken in the vicinity of the exposed nickel mineralisation in an attempt to discover any concealed extensions.

MX 4285

MX 5564
N 6471

Amongst the molybdenum anomalies the three strongest (Craiglowrie Hill, Loch Ken, Little Water of Fleet) were investigated geochemically, by further stream sampling, base of slope soil sampling and soil sampling along the forestry rides. Enhanced values were located in soils at Craiglowrie Hill and minor non-economic molybdenite mineralisation was found to be the source of the anomaly. Both at Loch Ken and Little Water of Fleet the anomalies proved to be very small in extent with no increase in values. The results are attributed to very minor molybdenite within the granite possibly enhanced by manganese precipitation in the streams.

Low order stream sediment anomalies on the northern side of the Fleet granite were traced to minor chalcopyrite mineralisation in quartz veins. Whereas similar low order values along the southern flank of the Merrick granite emanate from the pyritic black shales exposed in that area.

Geological mapping, reconnaissance soil sampling and magnetic surveys were undertaken in the vicinity of the copper/nickel mineralisation exposed in Glen of the Bar, and the central part of the grid was surveyed in detail. The results of the detailed work confirm that the mineralisation has a very limited extent. No manifestation of possible lateral extensions were obtained from the more widely-spaced surveys, and it was concluded that no extensions to the known mineralisation exist, within the range of the techniques used.

2.2 Cockermouth

Reconnaissance soil and stream sediment sampling outlined a large but moderate copper anomaly in Cockermouth Area. Follow-up soil sampling confirmed the continuity and extent of this anomaly. A reconnaissance I.P. survey was carried out but unfortunately a buried water main interfered with this survey over the main anomalous zone. Further detailed work will be undertaken in the autumn of 1972 which, if encouraging will justify the isolation of this area from project AE3 to become the subject of a separate grant application.

2.3 Dalbeattie

Following the reconnaissance stream sediment survey soil sampling was undertaken in four areas where anomalous values were recorded; Aireland Moor, Barclesh Hill, Barcloy-Whitehills and Rascarrel. Closely-spaced stream sediment samples were collected in Cushat Wood following up some results supplied by the I G S. Here the anomalous lead/zinc values were traced back to an out-cropping barytes vein.

At Aireland Moor the soil sampling located scattered and discrete anomalies for both copper and molybdenum that will require further follow-up.

The soil sampling at Barclesh Hill did not reveal any anomalous values and no further work was undertaken.

Anomalous values for copper up to 840 p.p.m. were recorded near Colvend on the Barcloy-Whitehills grid. These values were further investigated with detailed soil sampling which showed that the anomaly was completely confined to an area of very peaty soil. No further work was undertaken.

Soil sampling was also undertaken at Rascarrel in search of extensions to the recorded copper mineralisation in that area. No anomalies worthy of further work were discovered.

2.4 Mullach nan Coirean (Moorfoot)

Moderately anomalous molybdenum values were located along the southern and western contacts of the Mullach nan Coirean granite, as well as low order copper values. The copper occurs only in streams draining black pyritic shales and geochemical checks on rock samples confirmed the black shales as the source of copper. Along the


contour, soil sampling was carried out over the molybdenum anomalies, and the results required further follow up.

2.5 Clerich (Aviemore)

Reconnaissance sampling in this area revealed two groups of strongly anomalous values, one on the Alvie Estate and the second near Aviemore. On the Alvie Estate soil sampling outlined an anomalous zone close to the granite contact with some other scattered anomalous values. Both this and the anomaly near Aviemore require extensions of the original grid in order that the potential of the area may be fully assessed.

2.6 Fearn

A moderate anomaly was scheduled for further work in this area, and it was repeated with closely-spaced stream sediment sampling. It is intended that follow up soil sampling will be carried out.

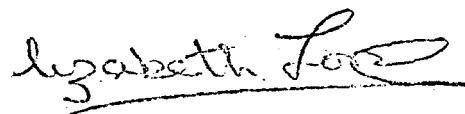

Elizabeth Jones

(In Map Cabinet)

LIST OF ENCLUSES

Talnotry and Creetown

- ✓ 1. Creetown, reconnaissance stream sediment results
Copper/Molybdenum/Tin/Tungsten.
- ✓ 2. Talnotry Forests, reconnaissance stream sediment results Copper/Molybdenum.
- ✓ 3. Talnotry Forests (Part): reconnaissance stream sediment results, Nickel.
- ✓ 4. Talnotry Molybdenum Areas - Little water of Fleet: *
soil sampling Molybdenum.
- ✓ 5. Talnotry Molybdenum Areas - Loch Ken: soil sampling
Molybdenum results.
- ✓ 6. Talnotry Molybdenum Areas - Craiglowrie: soil sampling Molybdenum results.
- ✓ 7. Talnotry Mine Area - reconnaissance soil sampling
Copper/Nickel.
- ✓ 8. Talnotry Mine Area - vertical magnetic intensity,
reconnaissance survey.
- ✓ 9. Talnotry Mine Area - detail soil sampling Copper/Nickel.
- ✓ 10. Talnotry Mine - Vertical magnetic intensity, detailed survey.

Cockermouth

- ✓ 11. Reconnaissance stream sediment sampling.
- ✓ 12. Reconnaissance soil sampling results: Copper.
- ✓ 13. " " " : Lead and Zinc.
- ✓ 14. " I.P. Chargeability values.
- ✓ 15. " I.P. Resistivity values.
- ✓ 16. " I.P. Gradient Array chargeability values.
- ✓ 17. Pit profiles and Geochemical profiles Copper, Lead, Zinc,
Mercury.

(In Map Cabinet)

Dalbeattie X

- ✓ 24. Reconnaissance stream sediment sampling results.
Copper, Molybdenum, Tin, Tungsten.
- ✓ 25. Aireland Moor soil sampling results - Molybdenum.
- ✓ 26. " " " - Copper.
- ✓ 27. Barclesh Hill " " - Molybdenum.
- ✓ 28. " " " - Copper.
- ✓ 29. Rascarrell soil sampling results - Copper.
- ✓ 30. Barcloy - Whitehills soil sampling results - Copper.
- ✓ 31. " " " - Molybdenum.
- ✓ 32. Colvend, detail soil sampling - Copper. ✓
- ✓ 33. Cushat Wood - Airdrie farm F.U. stream sediment results
Copper, Lead, Zinc.

Mullach

- ✓ 34. Reconnaissance stream sediment sampling results,
Copper, Molybdenum. ✓
- ✓ 35. Follow-up stream sediment sampling results, Copper,
Molybdenum. ✓
- ✓ 36. Soil Sampling results, Copper, Molybdenum.


Clerich (Aviemore) ✓

- ✓ 37. Reconnaissance stream sediment sampling results,
Copper, Molybdenum. ✓
- ✓ 38. Alvie Estate; soil sampling results, Copper, Molybdenum. ✓
- ✓ 40. Kinreachy Estate; soil sampling results and follow-
up stream sediment results, Copper/Molybdenum. ✓

Fearn

- ✓ 42. Reconnaissance stream sediment sampling results,
Copper, Molybdenum. ✓
- ✓ 43. Follow-up stream sediment sampling results. ✓


COMMERCIAL: IN CONFIDENCE

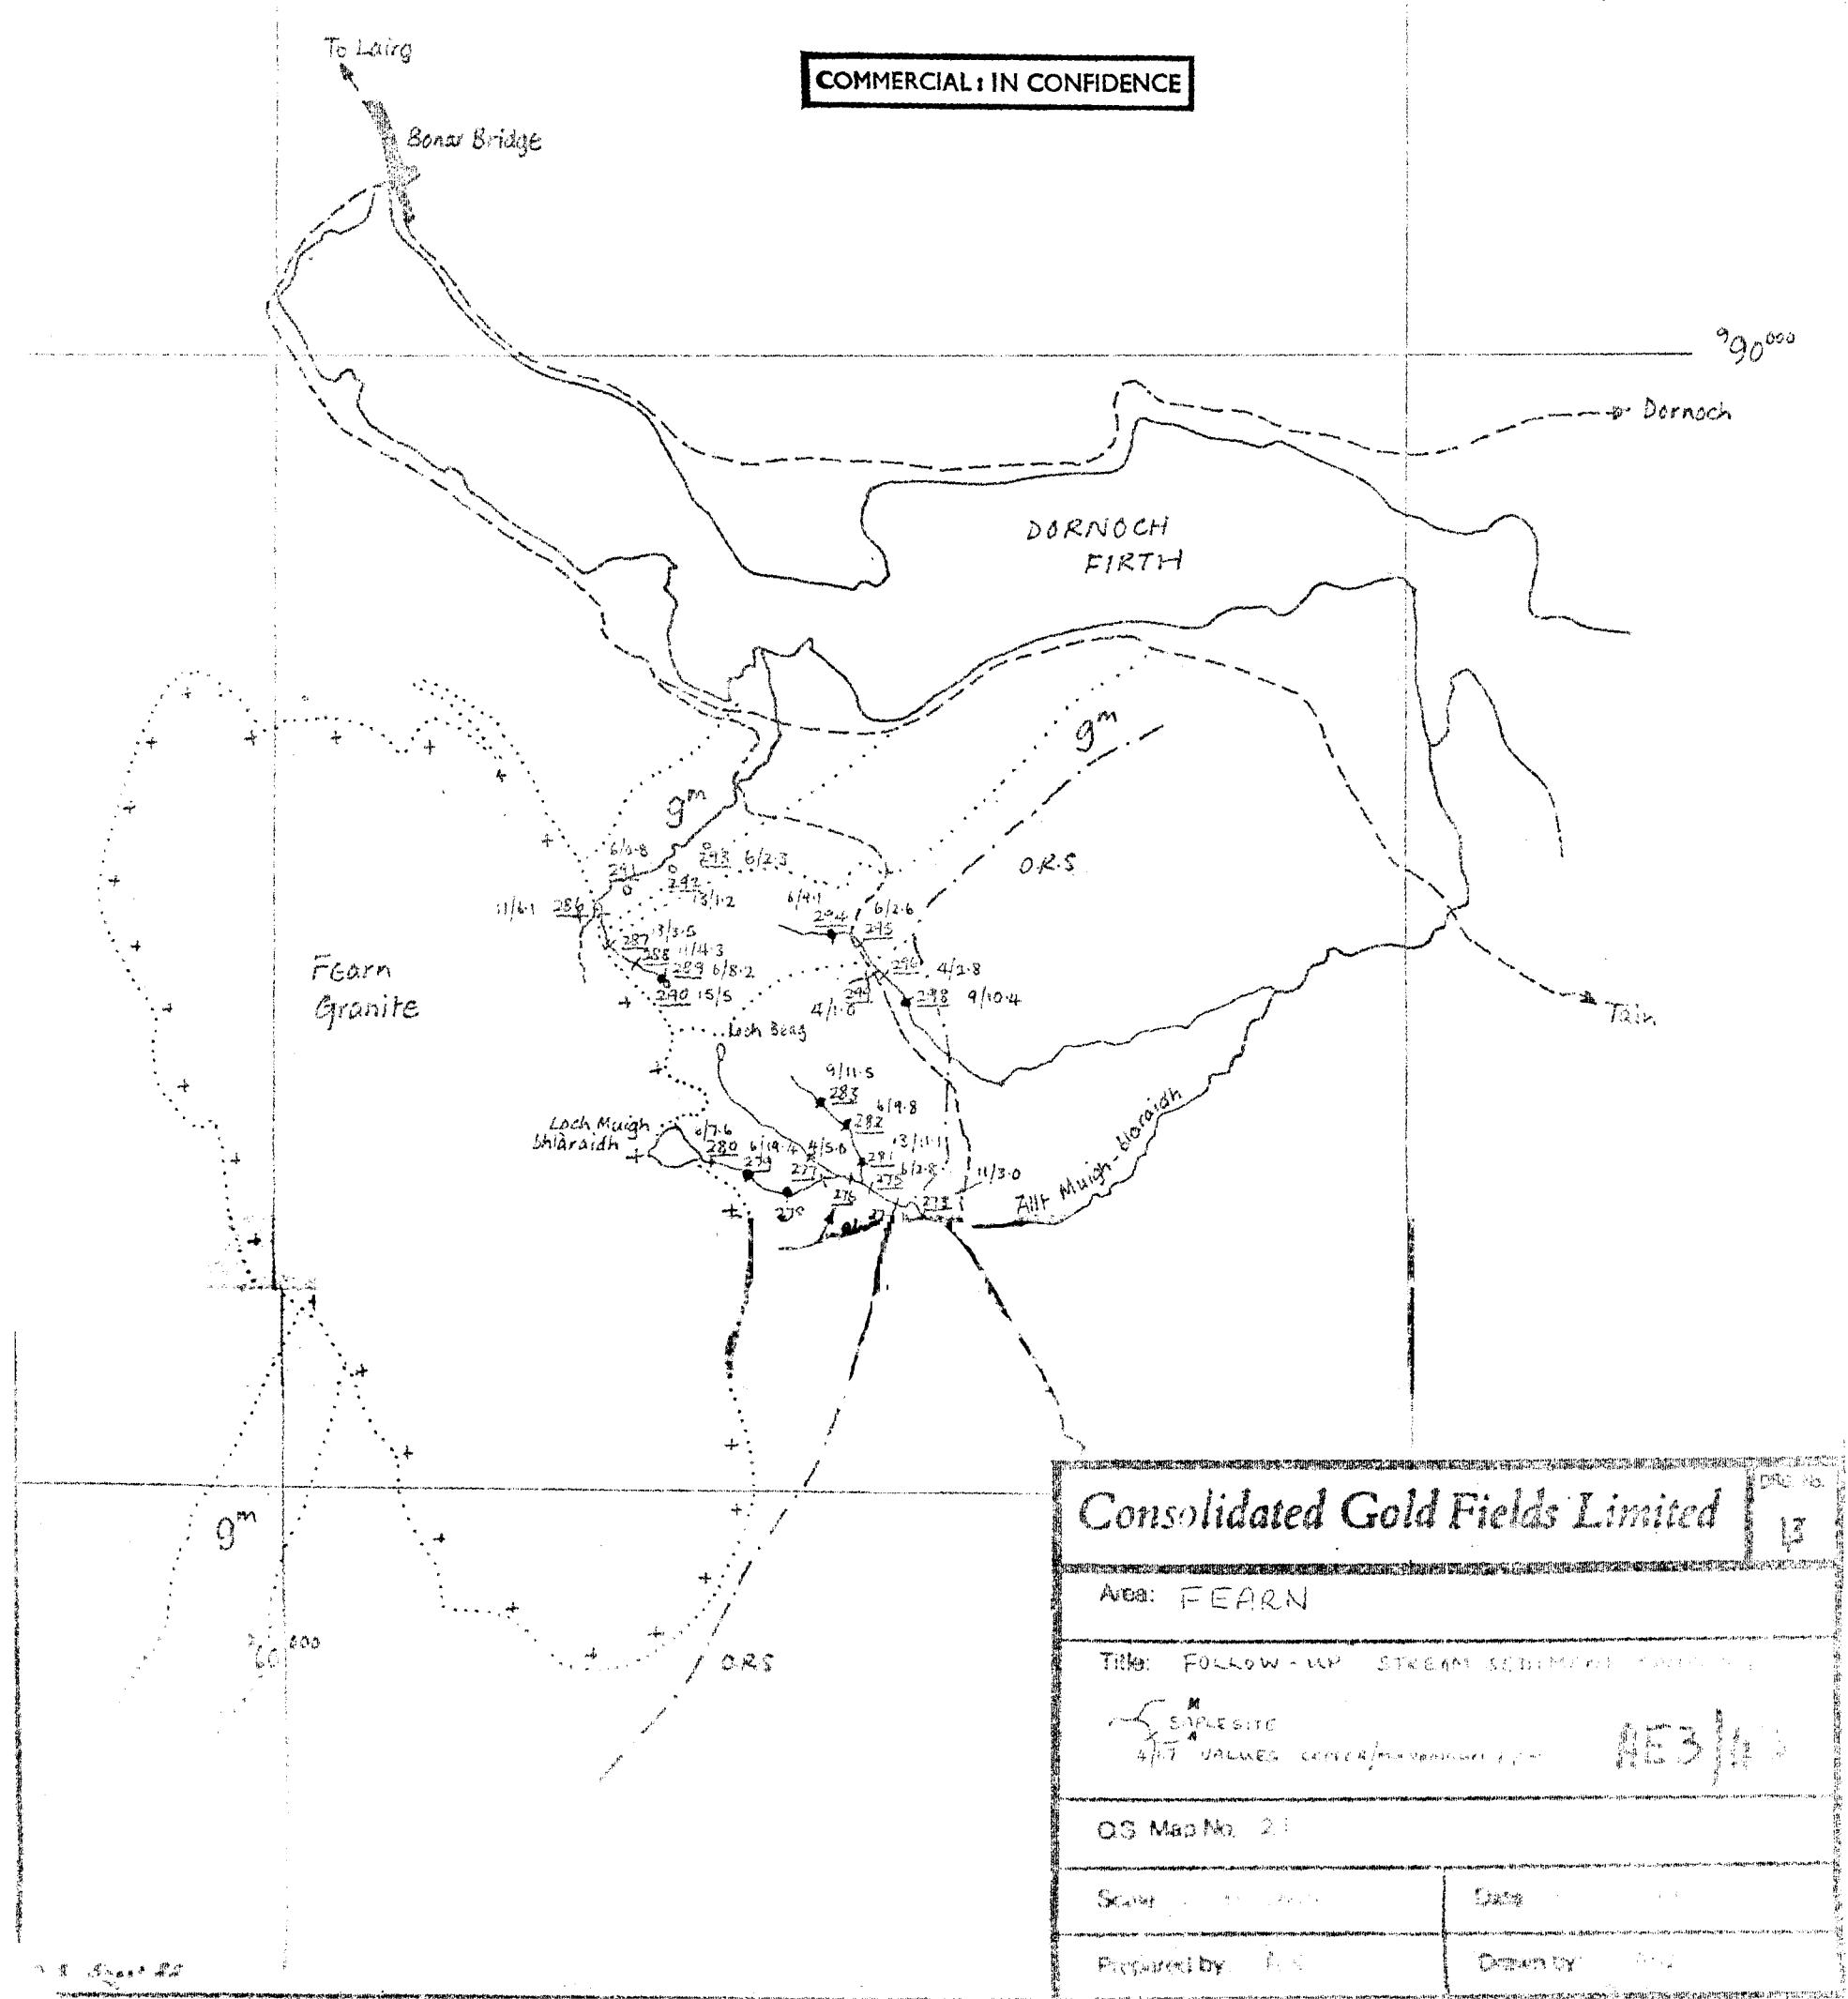

COMMERCIAL: IN CONFIDENCE

D65 Nn

34

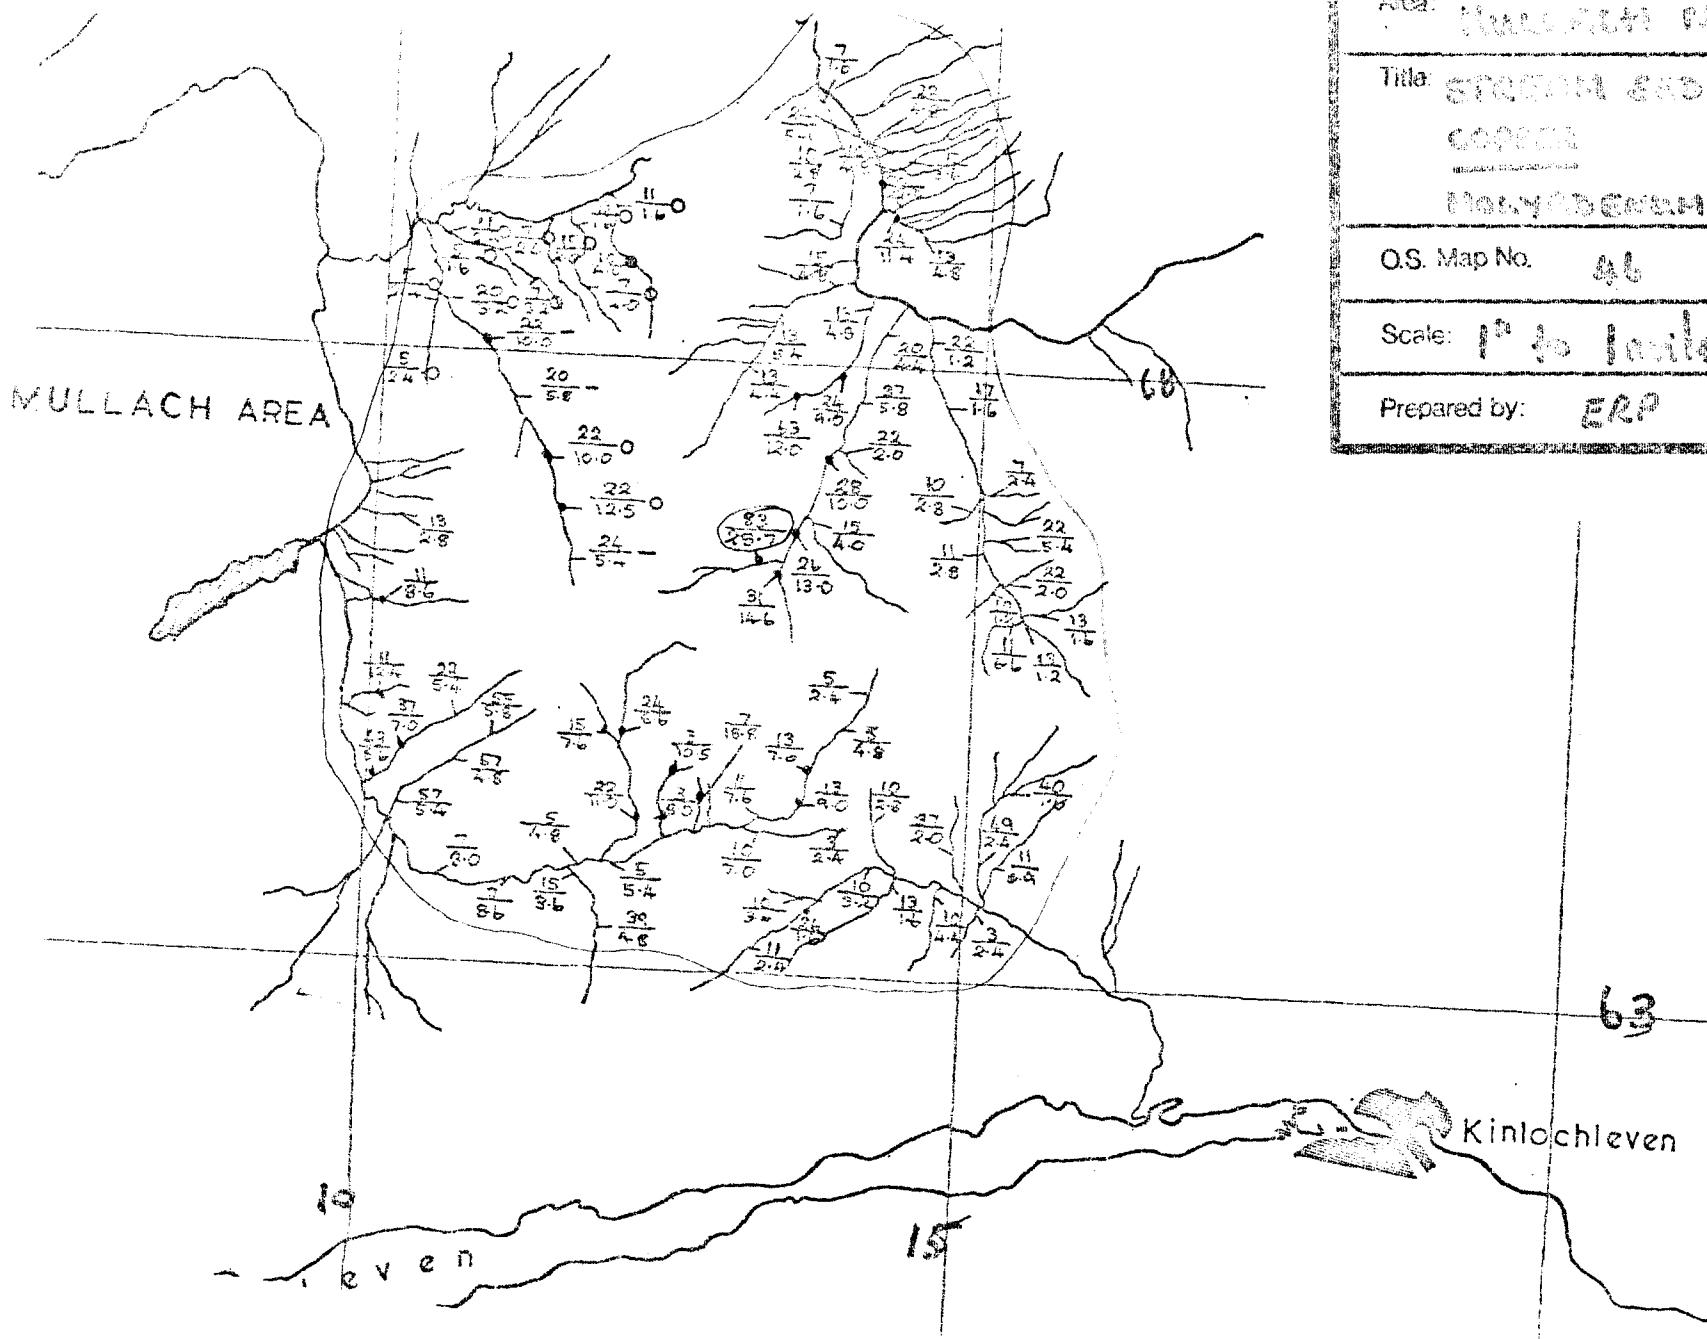

Consolidated Gold Fields Limited

Area: ~~High Priority Critical Locations~~

Title: SPECIAL EDUCATION PRACTICES

卷之三

Block 03 Context

Aesleay

O.S. Map No. 46

cale:  

Date: 1-26-1970

Prepared by: ERP


Drawn by: C.R.

Exam by: C PR

✓

63

Kinlochleven

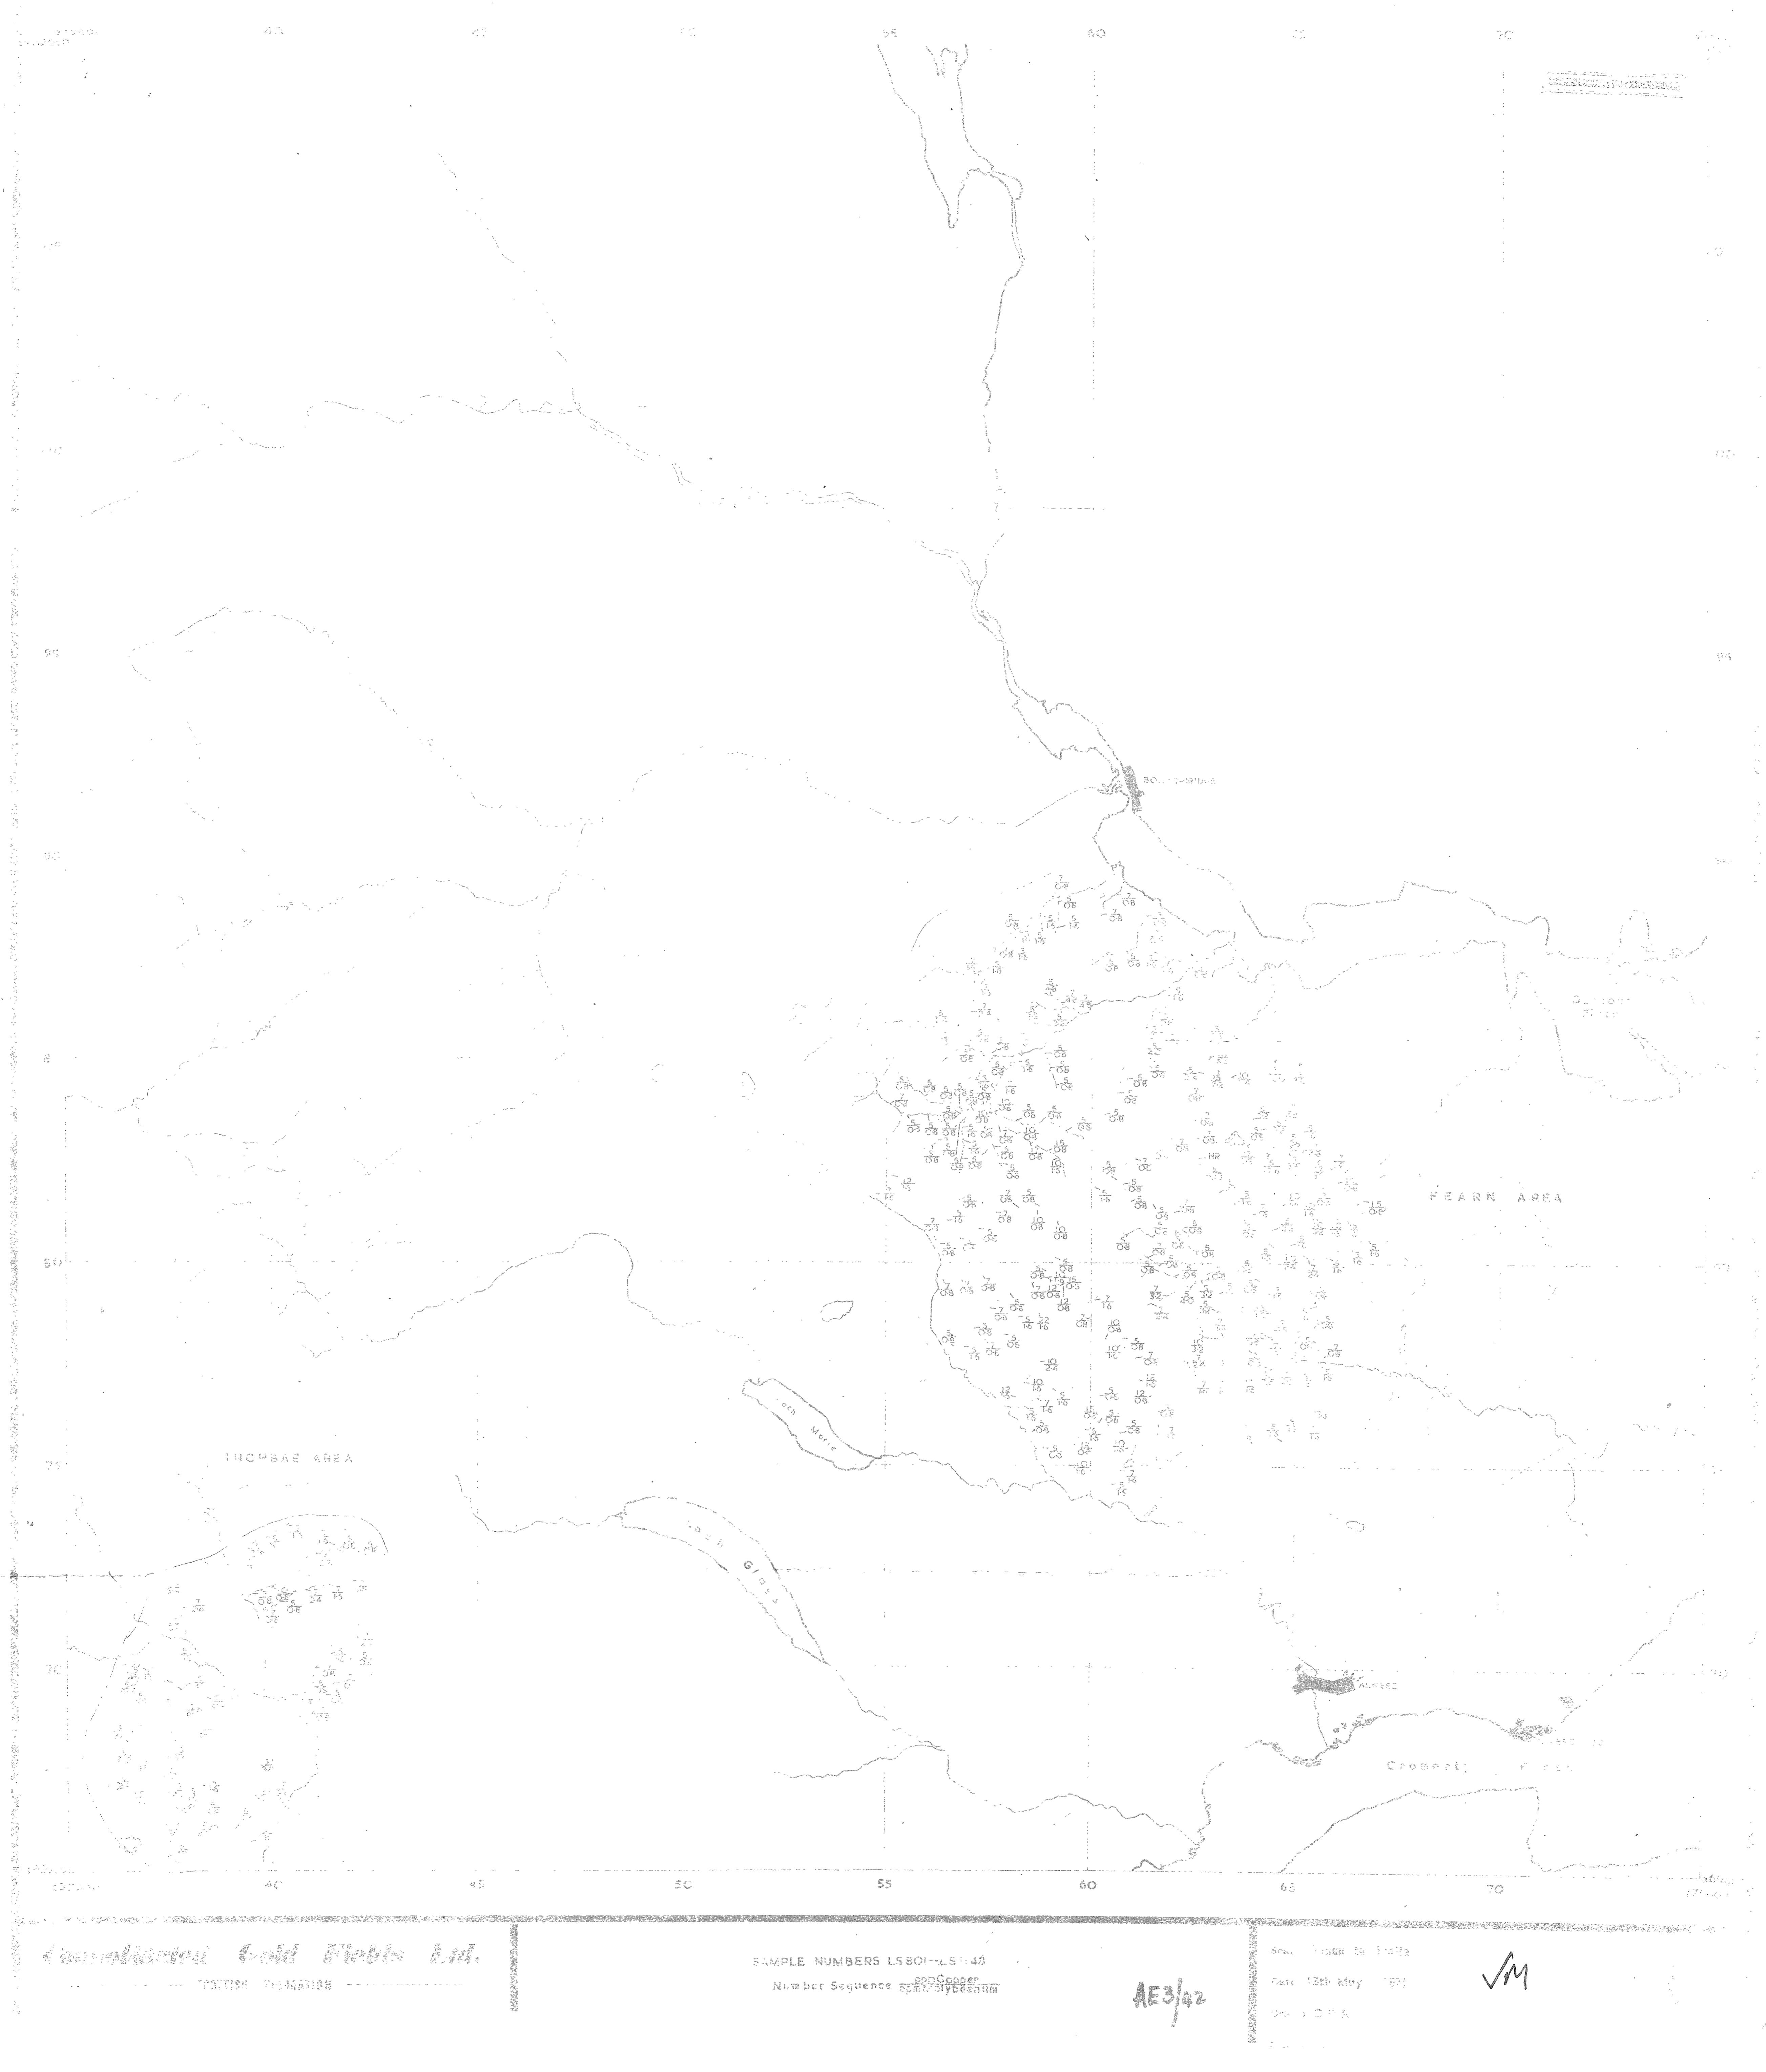

Mullach
nan Coirean

Stob Ban

Consolidated Gold Fields Limited		Drawn No. 35
Area: MULLACH NAN COIREAN		
Title: FOLLOW-UP STREAM SEDIMENT SAMPLING		
AE3/85		
OS. Map No. INVERNESS CLY, CLXVI		
Scale 6" to 1 mile	Date: February 1972	
Prepared by: ERF	Drawn by: ATW	

KI

AVIEMORE





NW	NE
SW	SE

Sheet consists of either
NW & SW or NE & SE

- 0-4.9 p.p.m Mo
- 5-9.9
- 10-19.9
- 20-39.9
- > 40

— extent of anomalous
stream sediment values

Consolidated Gold Fields Limited		DRG. No.
Area: AVIEMORE (CLERICHE)		
Title: KINVEACHY ESTATE.		
SOIL SAMPLING: S. EXTENSION OF GRID.		
SAMPLE LOCATION: VALUES: Cu - Mo in ppm.		
Q.S. Map No. INVERNESS LVIII.		
Scale: 6" to 1 mile.	Date: MARCH 1973	
Prepared by: WFL	Drawn by: S.M.	

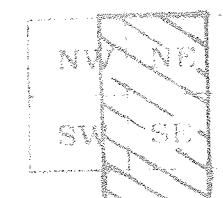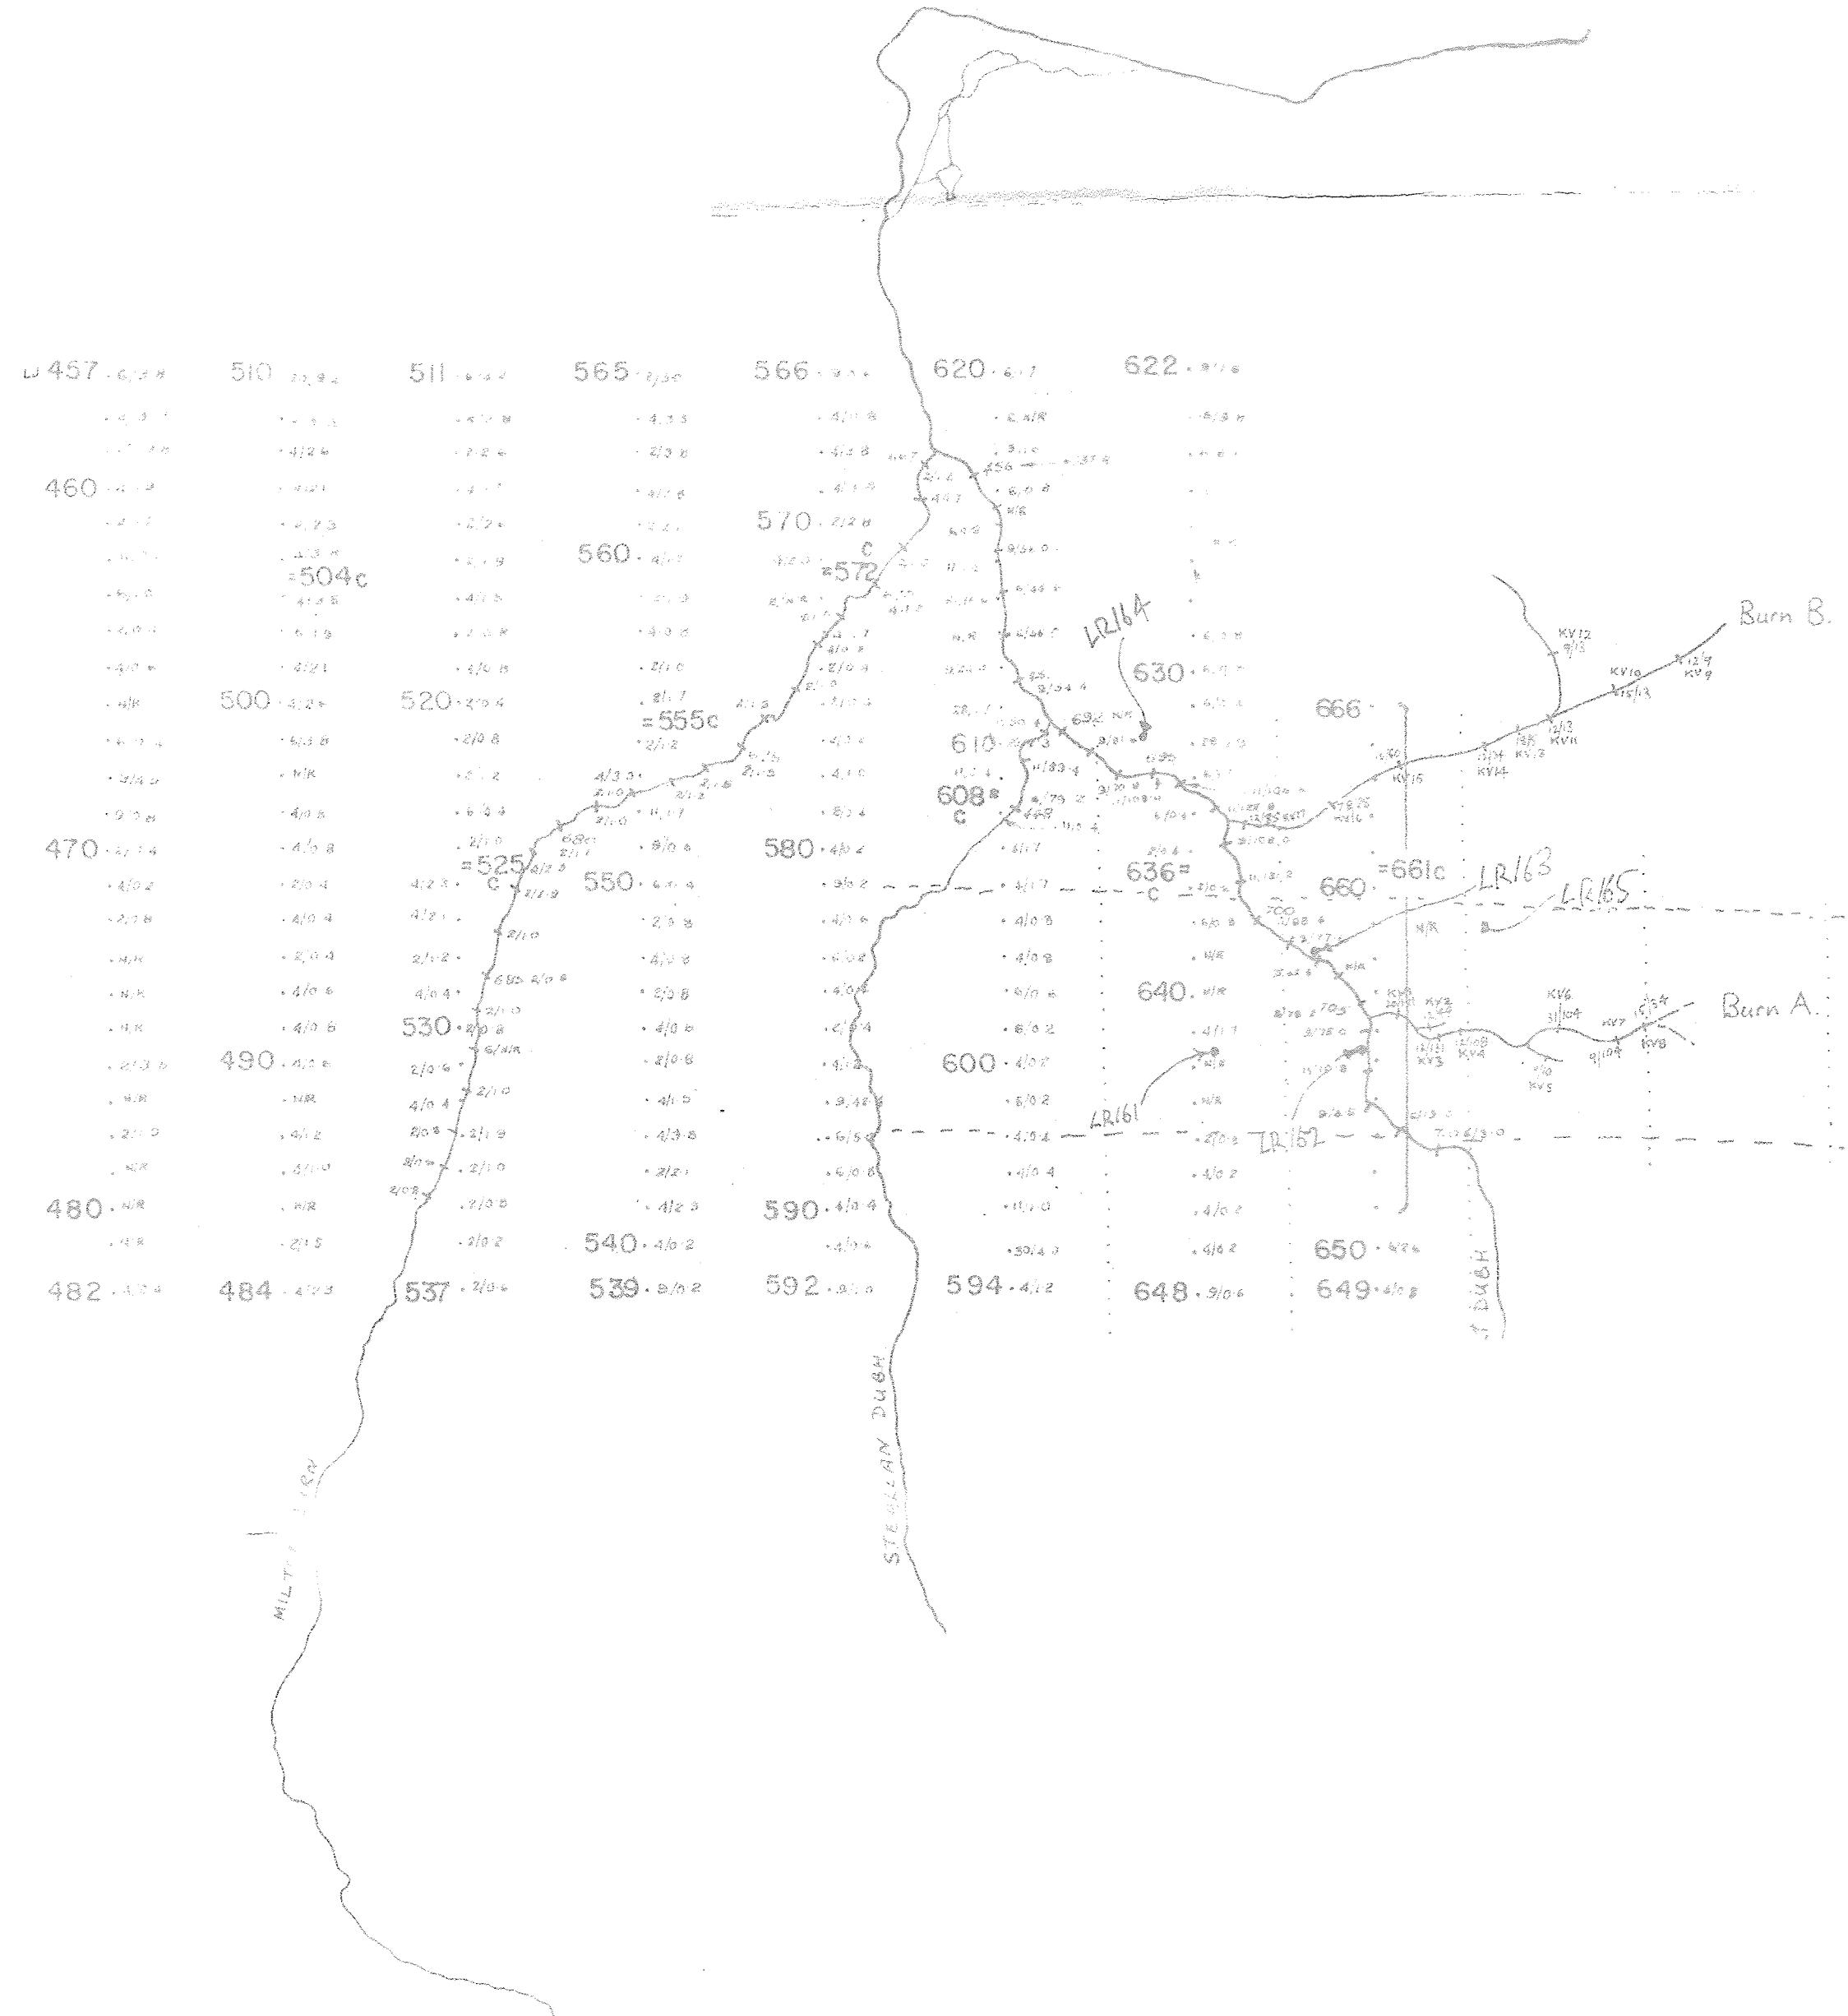

Sheet consists of either
NW & SW or NE & SE

STREAM SAMPLE

Cu Mo


466 SOIL SAMPLE

Pos. of peat soil sample locations

2861 Rock Sample positions

2752 Approx. limits of zone
of shearing

Consolidated Gold Fields Limited		DRG. No. 40
Area: AVIEMORE (CLERICHE)		
Title: KINNEACHY ESTATE FOLLOW-UP STREAM SAMPLING AND SOIL SAMPLING		
SAMPLE NO. LT 457-710 + KV1-17. Cu Mo AE3/40		
O.S. Map No. INVERNESS 1:250,000		
Scale: 6" to 1 mile		Date: MARCH 1972
Prepared by: ERP/WCL		Drawn by: B.P.

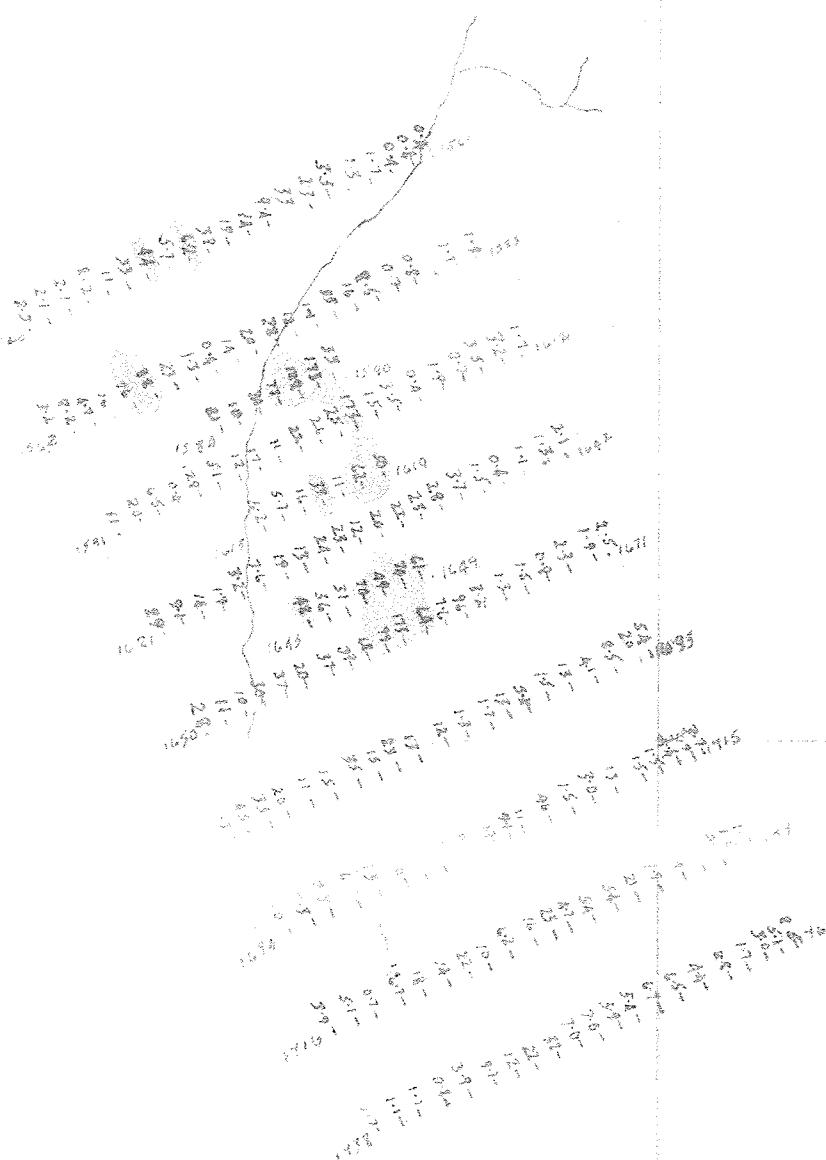

Consolidated Gold Fields Ltd.
EXPLORATION

Project: C.G.F


Area: AVIEMORE (CLERICH)

Title: ALVIE ANOMALY RECONNAISSANCE
Soil sampling

+ 7.3 MOLYBDENUM p.p.m

AE3/39

Drawing No.	O.S. Map No. NH 81 SW	
Scale:	1:10,000	Prepared by: E.R.P
Date:	DEC. 1972	Drawn by: H.G.
Revisions:		

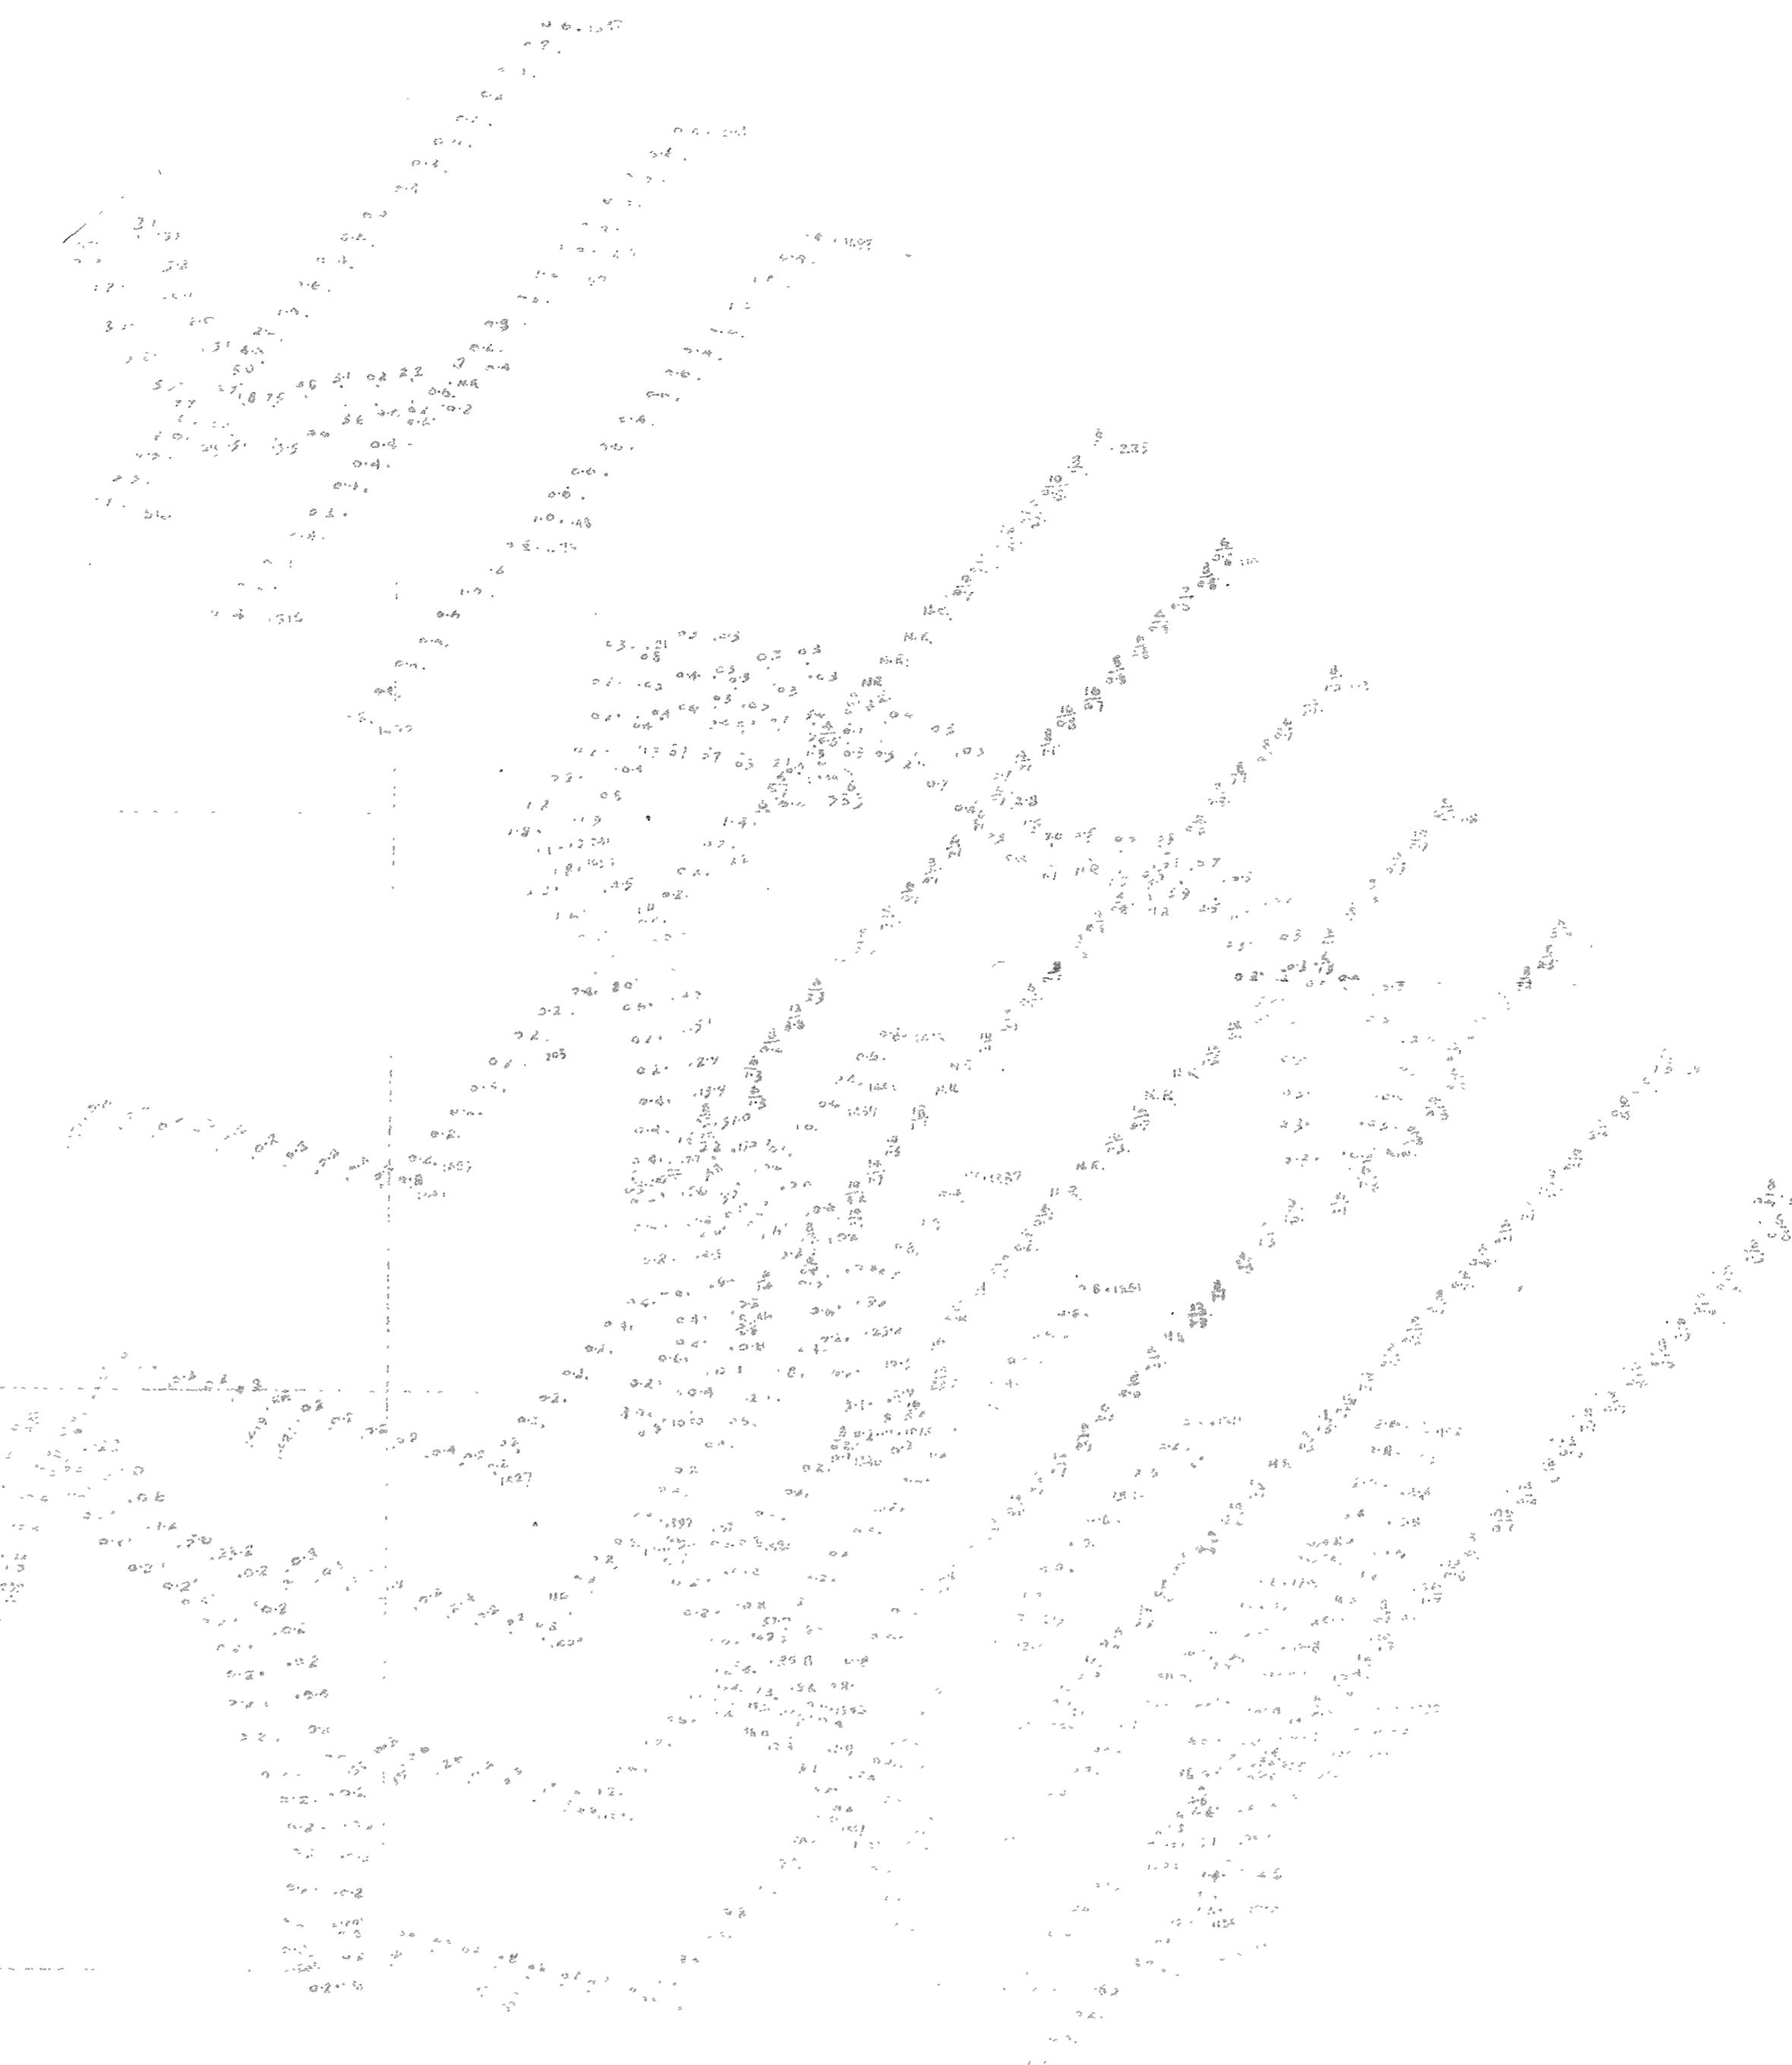

Alvie Estate Soil Sample Results

Sample No. 2133 SE. NHRI EV

Date: 3-3-72 Prepared by E.R.P.

Analyst: AVIEMORE (CLERCH) *VM*

Soil Sample Results - ALVIE ESTATE

Sample No.	Mo ppm	Cu ppm	Mn ppm
2-4-7 ppm Mo			
5-9-9 "			
10-19-9 "			
20-39-9 "			
740 ppm Mo			


Comments: AES/AB

38



<i>Consolidated Gold Fields Ltd.</i>		
EXPLORATION		
AVIEMORE	✓M	
Drainage Plan.		
STREAM SEDIMENT RESULTS Copper molybdenum		
Dir. No.	OS Sheet Nos. 28, 29, 37, 38	Prepared by J.A.
Geological Map No.	1:62500	J.A. B.P.
Scale 1" to 1 mile	Date Feb. 2 1962	
Revisions		

37

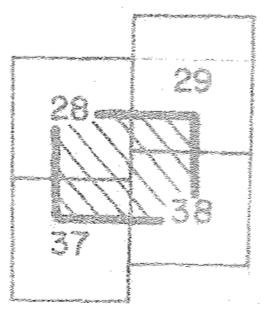

1. *Leucosia* *leucostoma* *leucostoma*
2. *Leucosia* *leucostoma* *leucostoma*
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19. *Leucosia* *leucostoma* *leucostoma*
20. *Leucosia* *leucostoma* *leucostoma*

TR. MULLACH - NAN - COIREAN AREA.
SOIL SAMPLING RESULTS.

- VALUES IN PPM.

AE3/36


INVERNESS

506

St. Paul and Rice, No. 1

M.TW

36

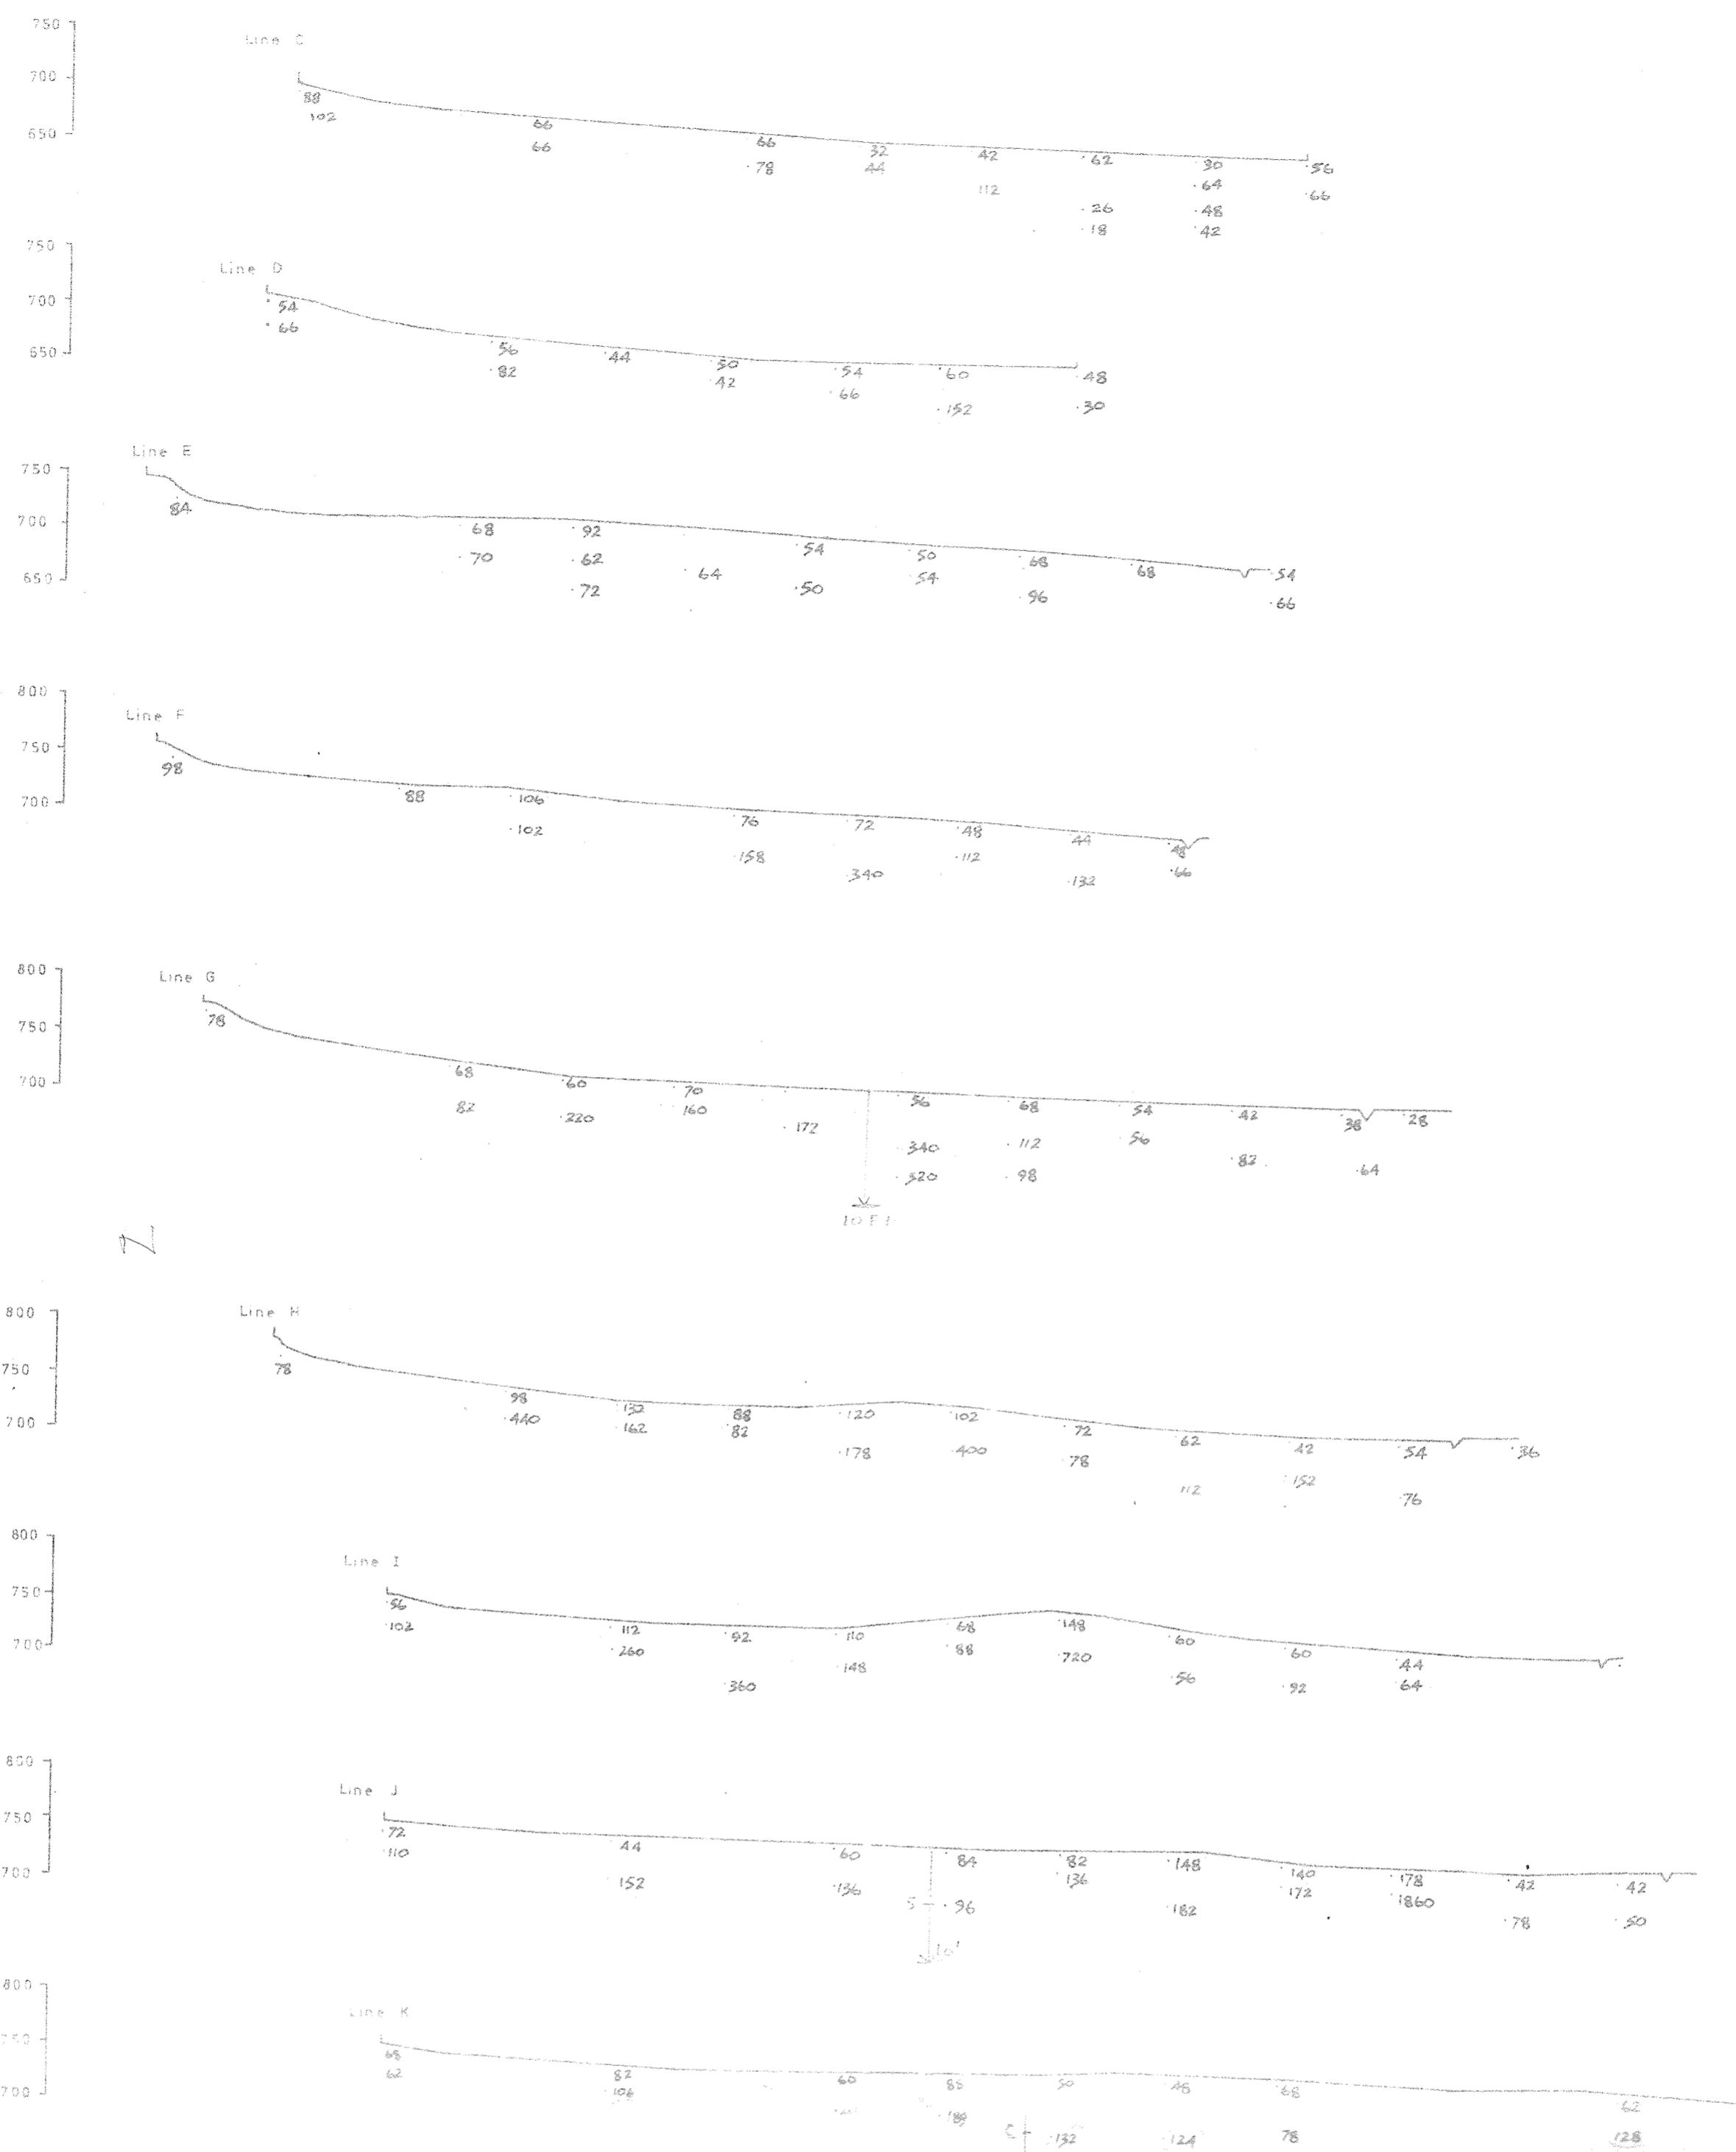

Consolidated Gold Fields Ltd.

EXPLORATION

Project: LAKE DISTRICT - COCKERMOUTH

Area: Torpenhow Anomaly

Title: SECTION - Lines C - K

Copper (Cu) p.p.m.

AE3/19.

Drawing No.

O.S. Map No. Cumberland - XLVI 3

Scale: 2 cm = 100'

Prepared by: E.R.P.

Date: Oct 1972

Drawn by: A.I.W.

Revisions:



Consolidated Gold Fields Ltd.
EXPLORATION COMMERCIAL IN CONFIDENCE

Project: Cu, Ni, Mo.
Area: DALBEATTIE AREA.

Stream sediment results -
CUSHAT WOOD and AIRDRIE FARM AE3/33
Sample numbers LD 1201 - 1270

Sheet No.	O.S. Map No. NX 96 SE 95 NE
Scale: 6" to 1 mile	Prepared by: G.L.P.
Date: May 1972	Drawn by: A.T.W.
Revisions:	

33

✓ Cu 11
Zn 11

STREAM SEDIMENT SAMPLE
VALUES Cu, Pb ppm.



COMMERCIAL IN CONFIDENCE

Consolidated Gold Fields Ltd.


EXPLORATION

Title: DALBEATTIE AREA.

Soil sampling, COLVEND (see plan for locations)
Sample numbers, LD 2170-2401

AE3|32

Drug No.	O.S. MAP N. NX 85 SE 6 th	Preparation by G.L.P.
Geological Map No.	Date Apr. - 1972	B.R.
Scale 1:2500	Date	Apr. - 1972
Revisions		

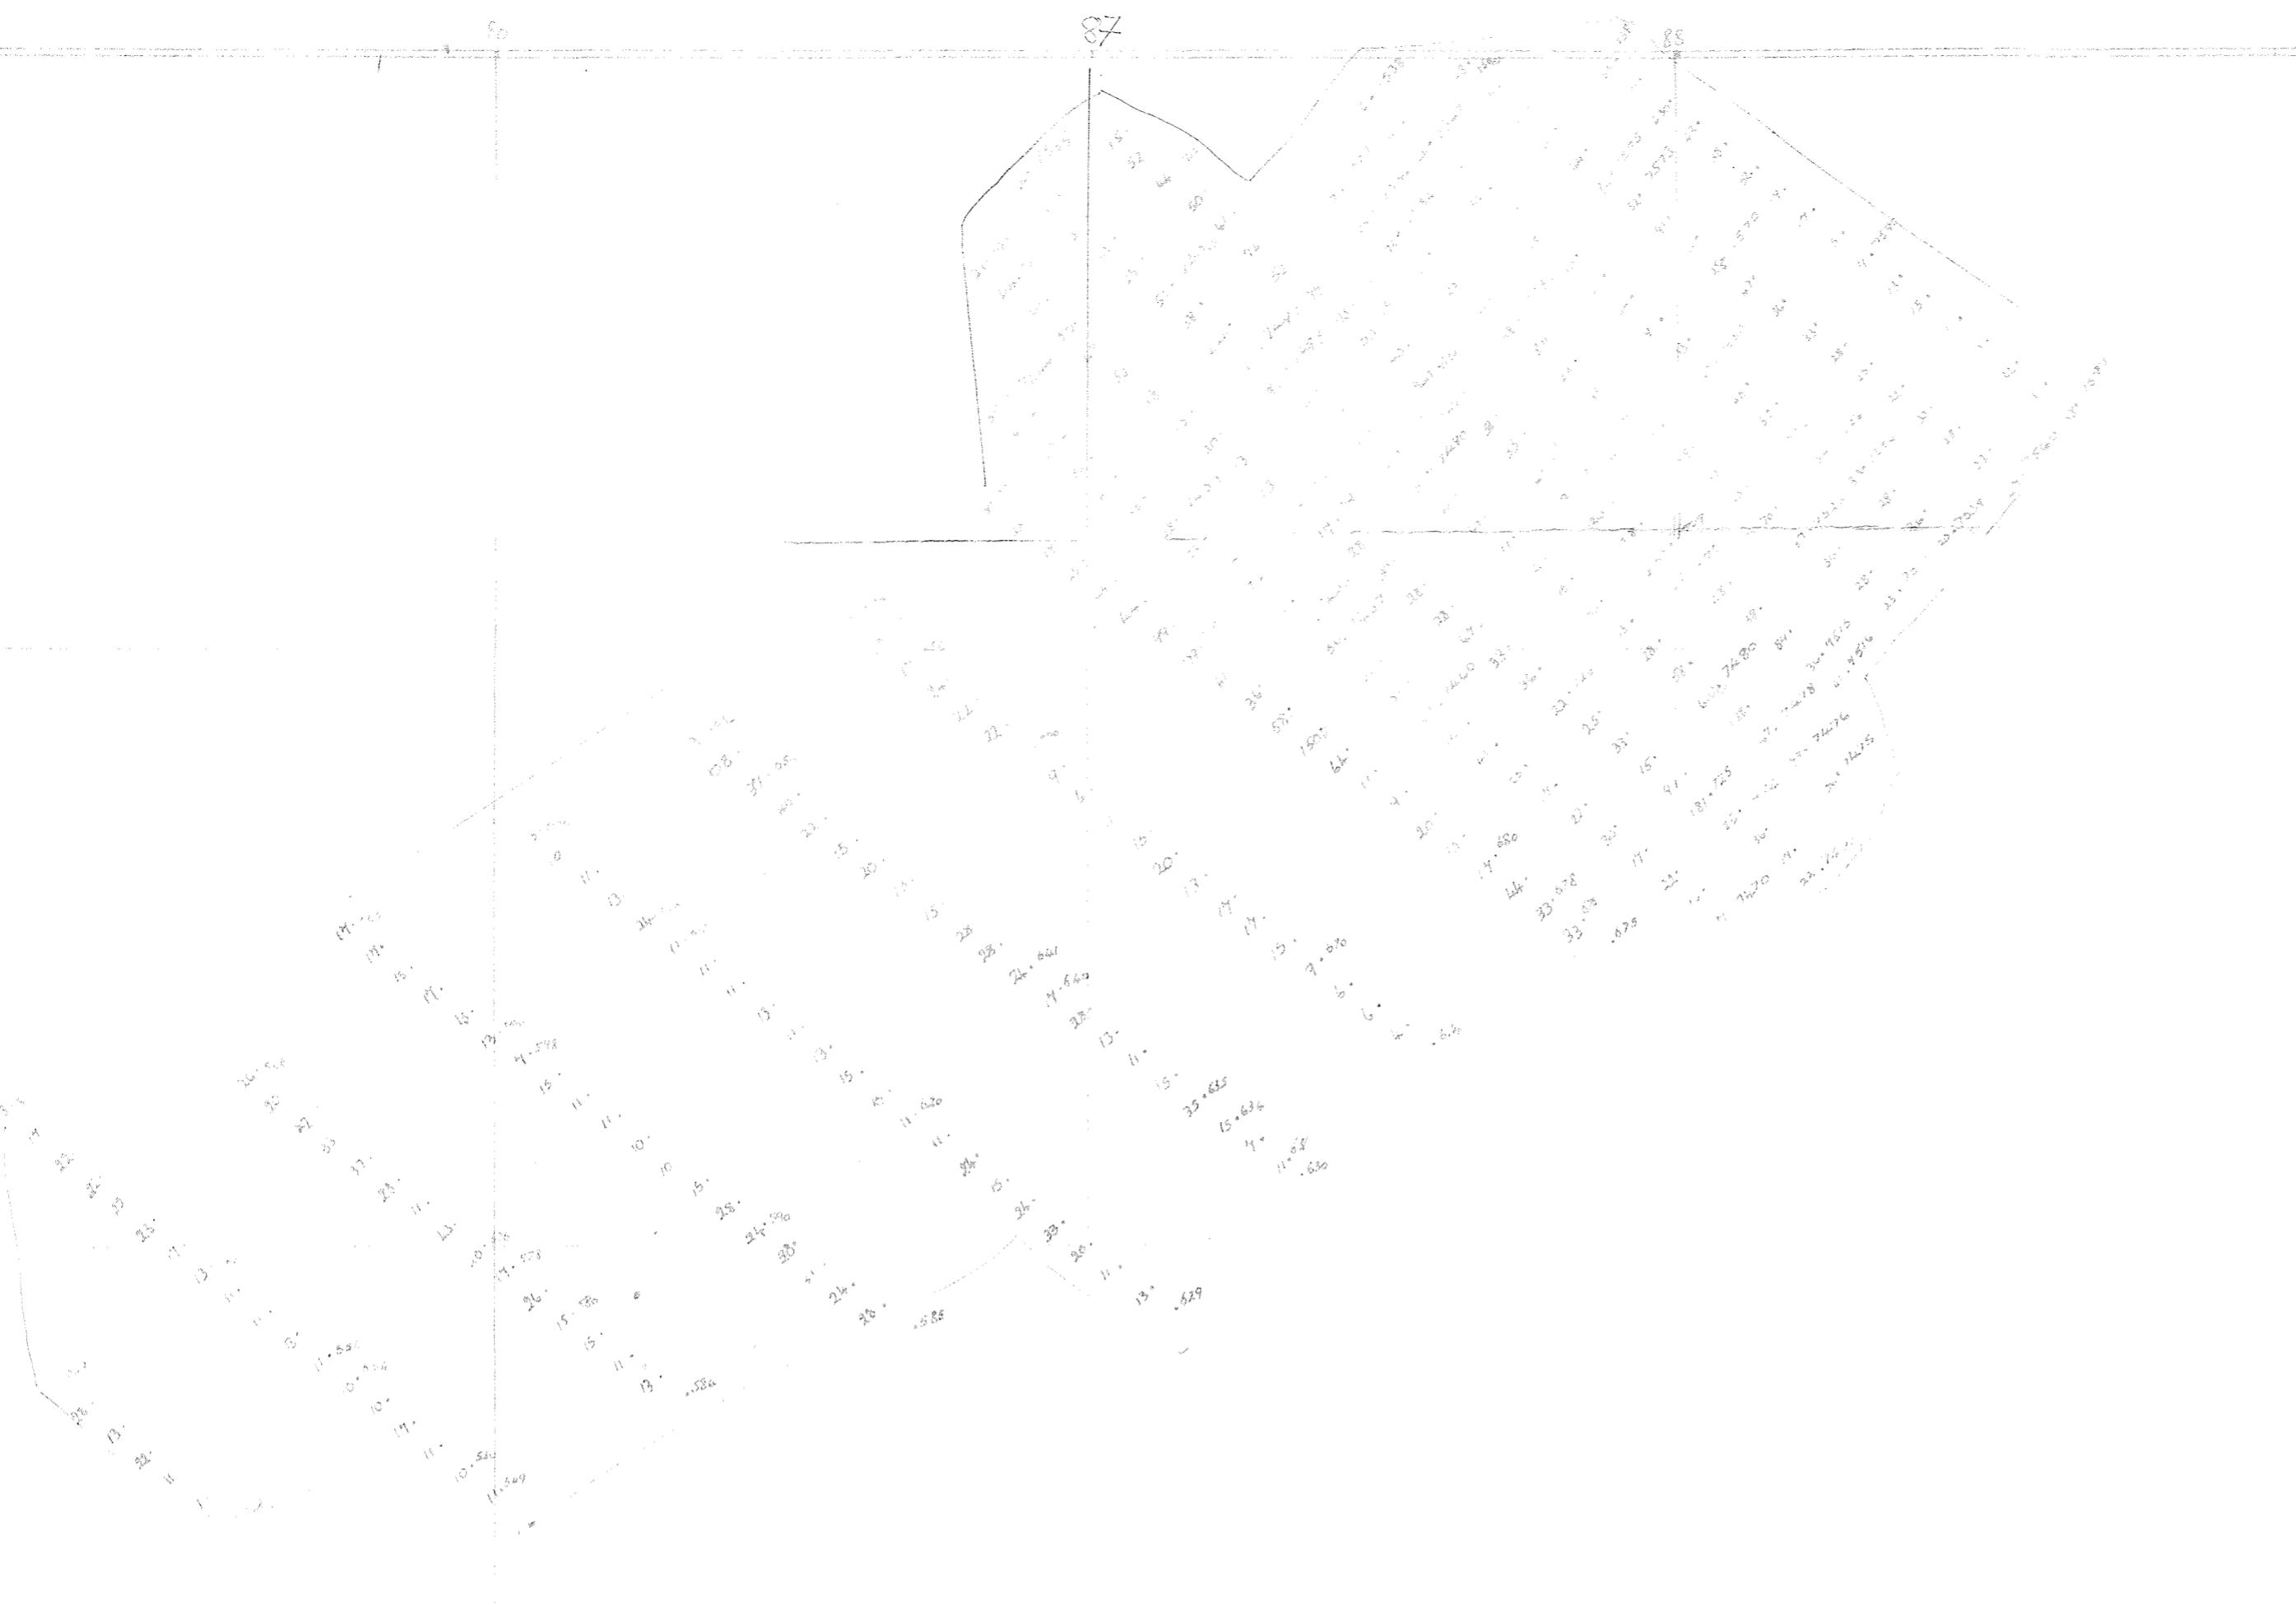

~~INFORMATION IN CONFIDENCE~~

Consolidated Gold Fields Limited		DRG No 30
Area: DALBEATTIE		
Title: BARCLAY - WHITE HILLS		
SOIL SAMPLING		
Cu ppm & SAMPLE NO.		
AE3 30		
O.S. Map No. 81 (NX 855E)		
Scale: 1" to 1 mile	Date: DECEMBER 1971	
Prepared by: ERP	Drawn by: GM	

Consolidated Gold Fields Ltd

EXPLORATION

COMMERCIAL - IN CONFIDENCE

DAI BEATTIE AREA

RASCARREL - Soil sample grid

Sample numbers LD.1903 - 2166

Sample No Cu ppm


AE3124

P.L.	OS MAP No. NX74NE, 64NW	Reproduced G.L.P.
	Ordnance Survey Map 8000	B.P.
29	6" to 1 mile	1933 Apr. 17 1932

Consolidated Gold Fields Ltd.
EXPLORATION

Title DALBEATTIE AREA
BARCLUS HILL
Soil Sampling Results
Copper ppm = SAMPLE NO.
AE3/28

Drg No	O.S. MAP NO NX86SE, SW	Prepared by ERP
Geological Map No	Drawn by GM	
Scale 1:63,360	Date DECEMBER 1971	
Revisions		

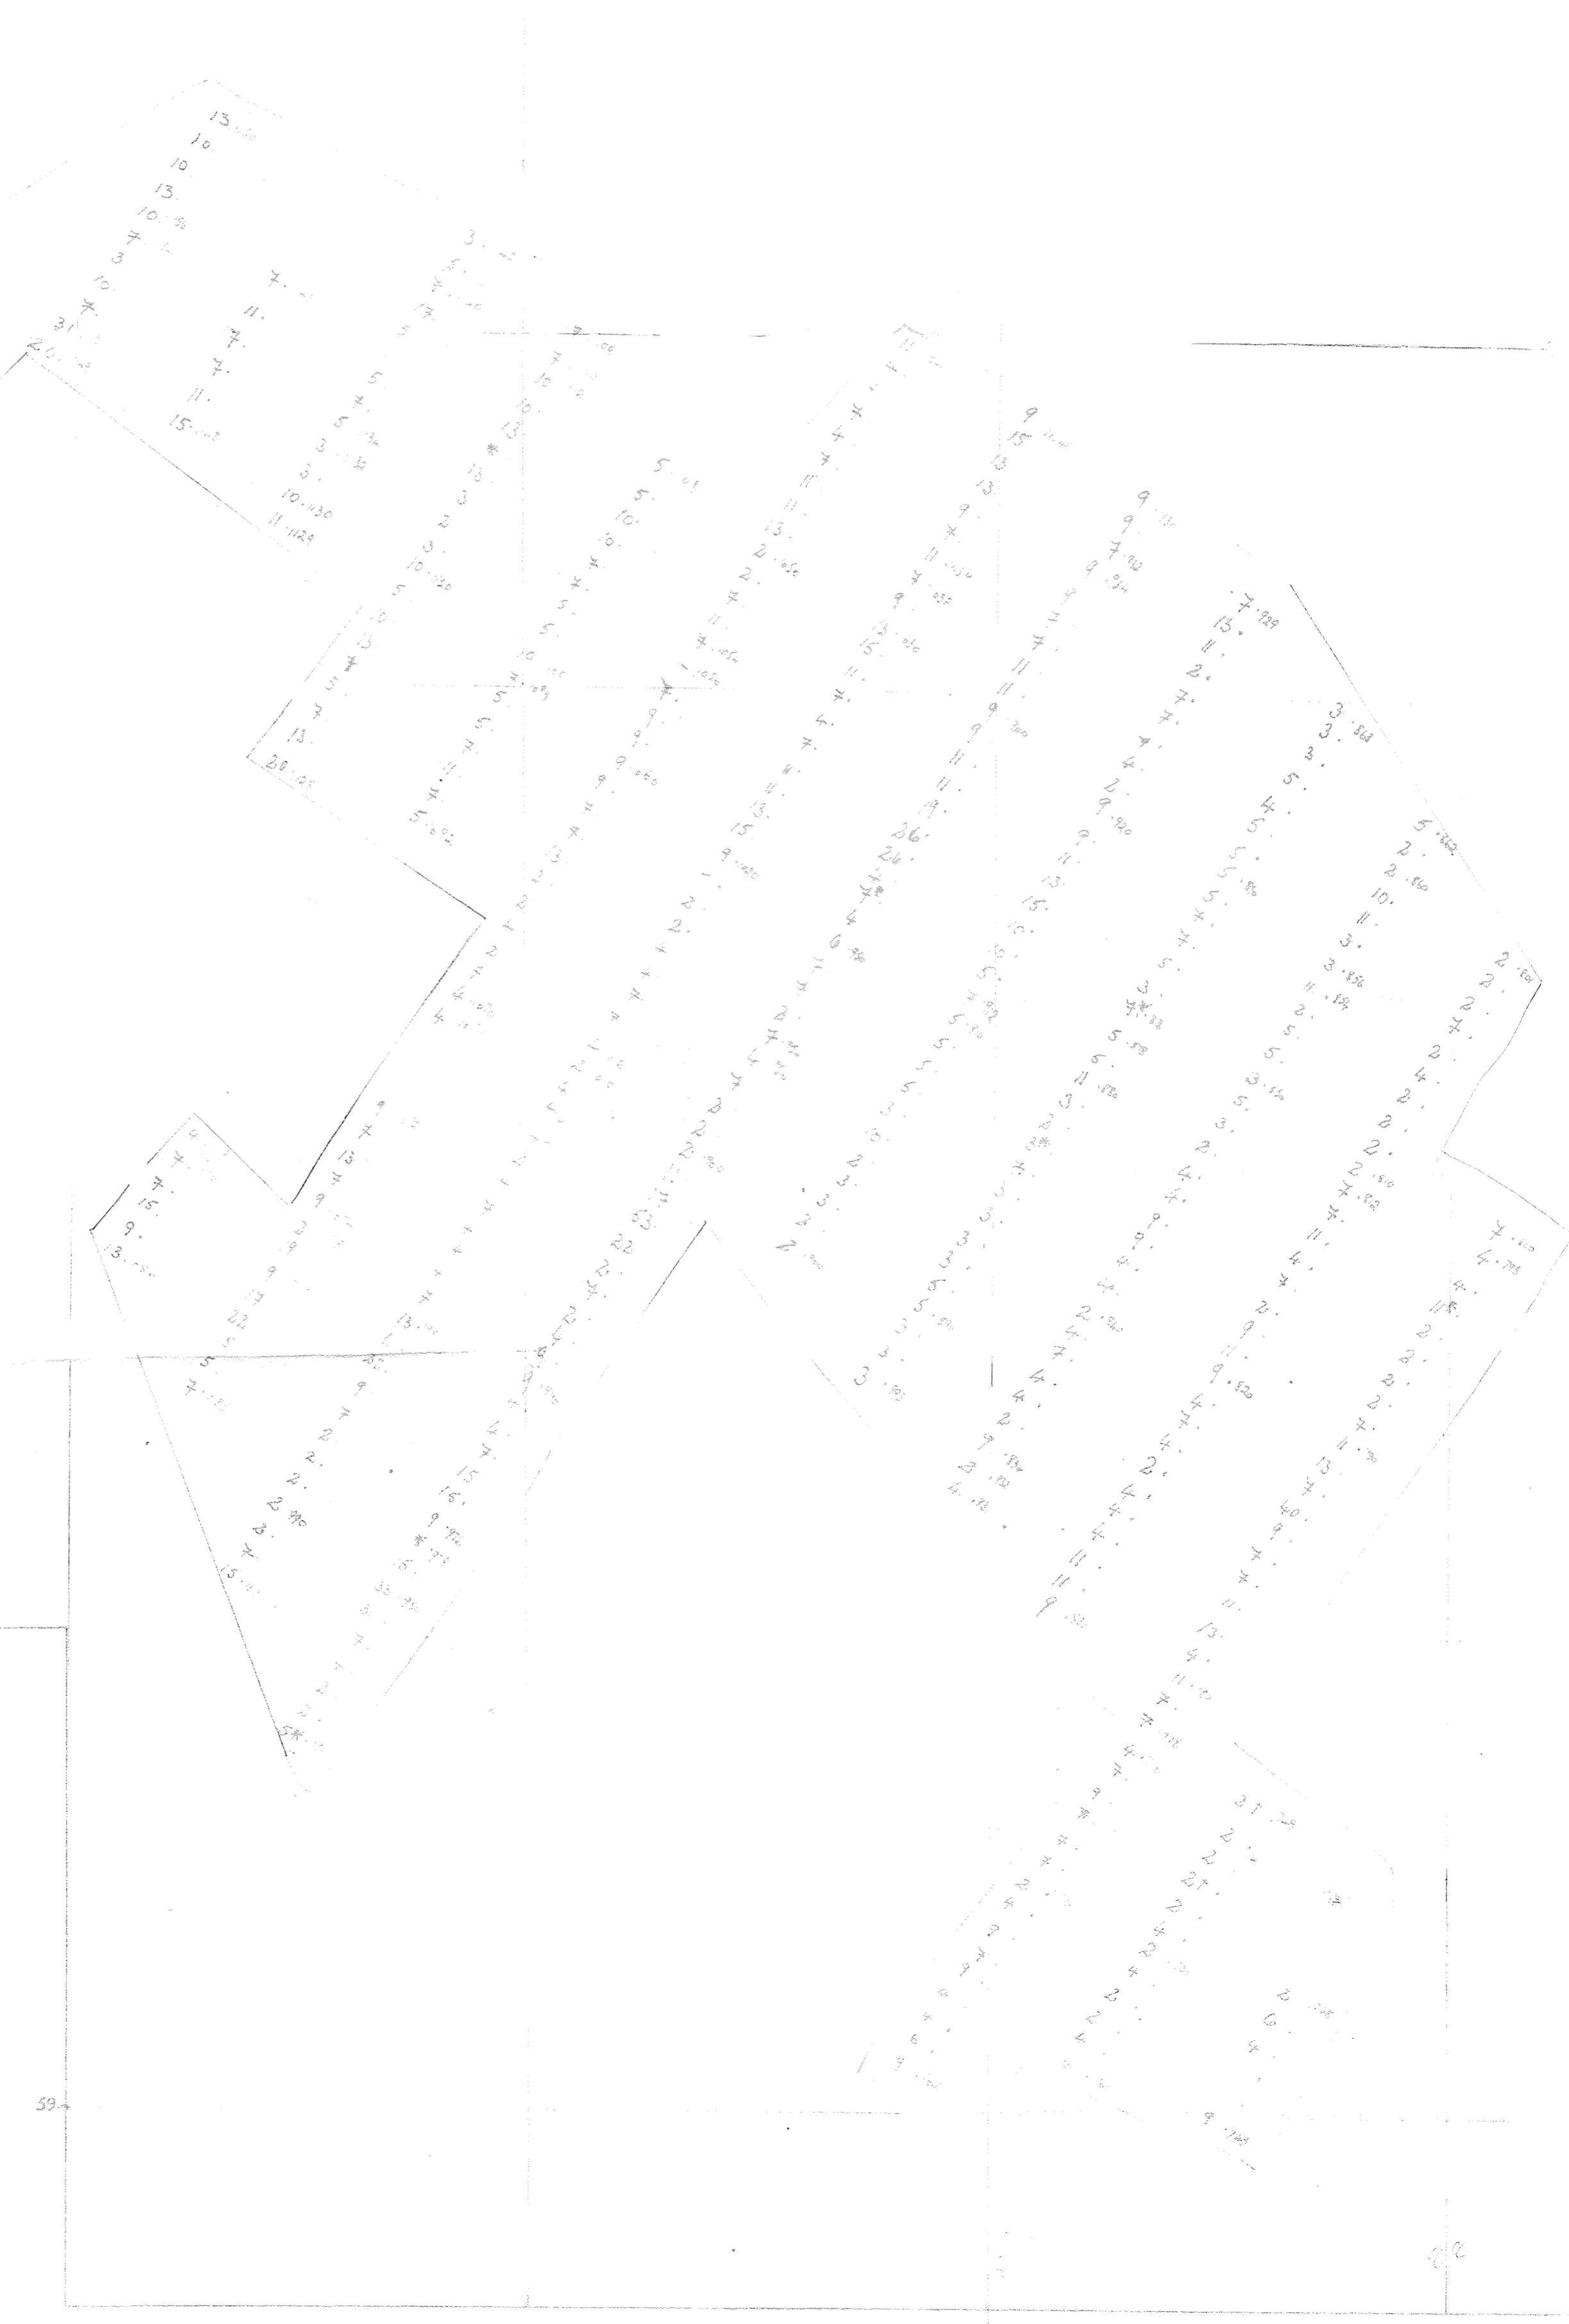

Consolidated Gold Fields Ltd.

EXPLORATION

Title: DALBEATTIE AREA

БАССЮЕВИЧ НИКІ

SOIL SAMPLING RESULTS

MOLYBDENUM PPM. SAMPLE NO.

COMMERCIAL : IN CONFIDENCE


AE3/27

Dr. St.

26

Revisions

For more information about the study, please contact Dr. Michael J. Hwang at (310) 206-6500 or via email at mhwang@ucla.edu.

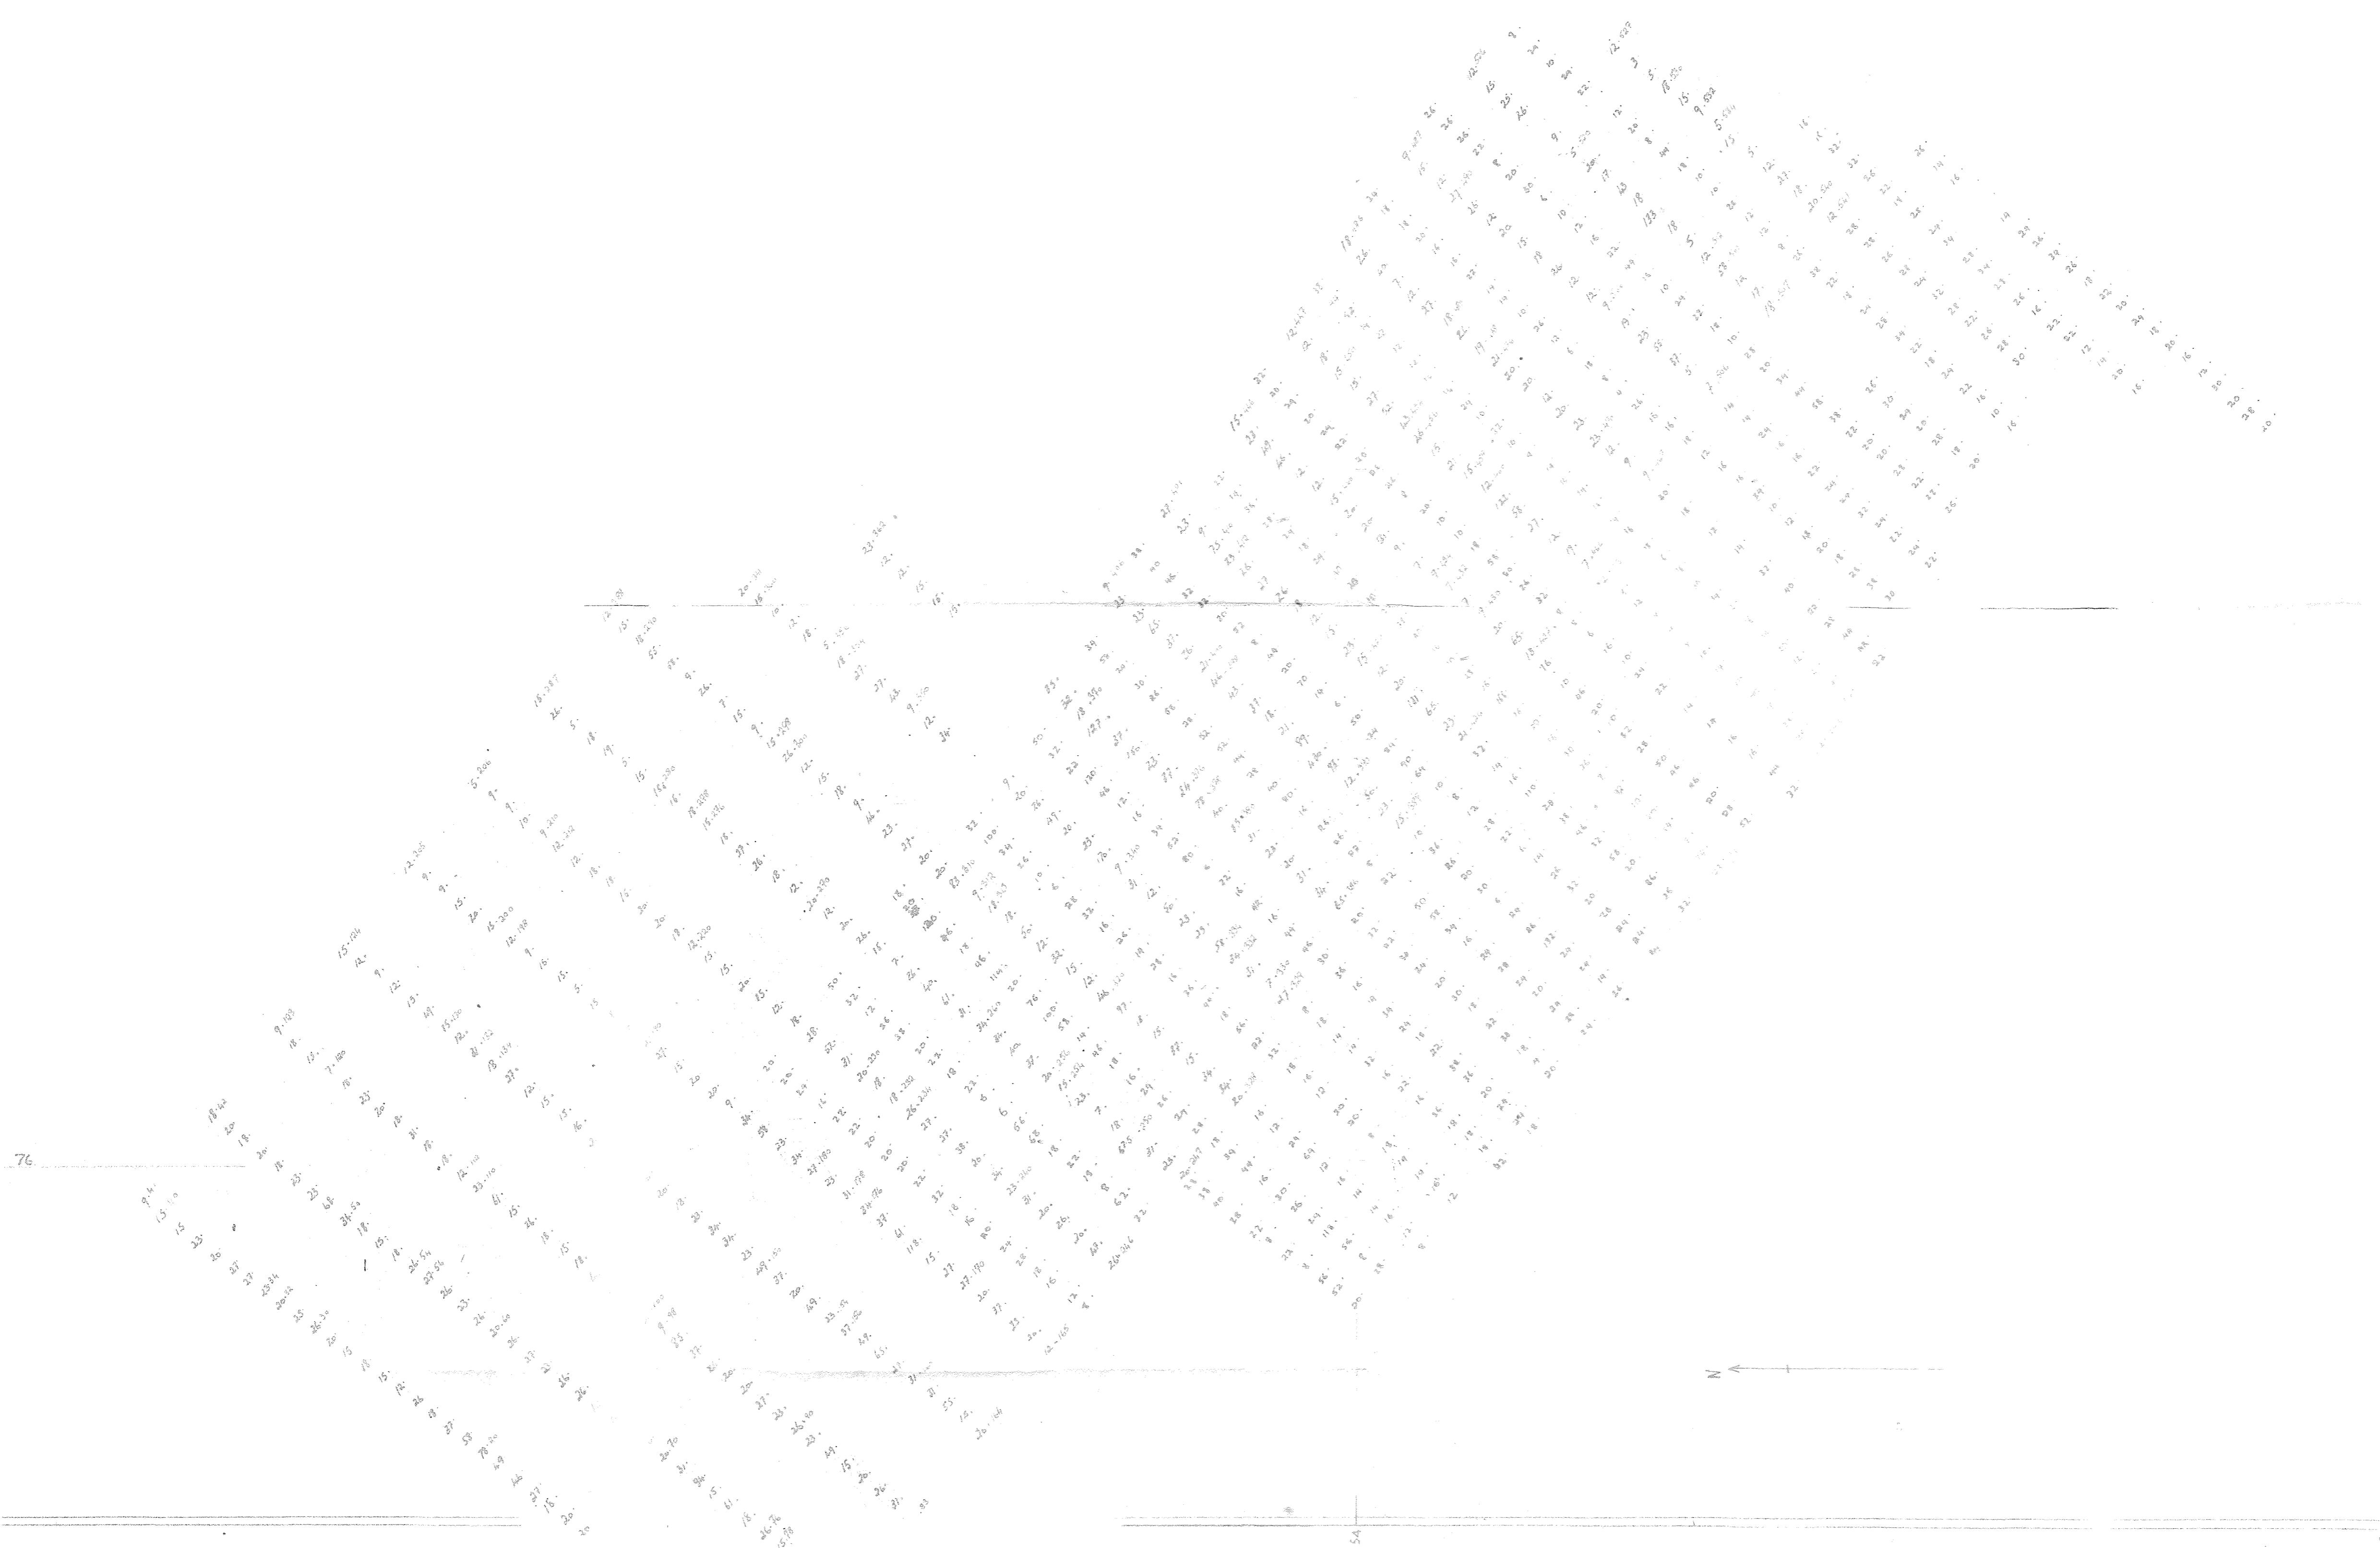

Consolidated Gold Fields Ltd.

COMMERCIAL IN CONFIDENCE EXPLORATION

FIG. DALBEATTIE AREA - AKELAND MOOR.

SOIL SAMPLING RESULTS.

COPPER P.P.M. = SAMPLE NO.

AE3/26

Deg N	Ordnance Map No NX75NE, 75SE	Prepared by E.R.P.
✓	Geological Map No	Drawn by G.M.
26	Scale 6" to 1 mile	Date DECEMBER 1972
	Revisions	Map Sheet 929 May 1972

Consolidated Gold Fields Ltd.

DALBEATTIE AREA AREA AND STATE

SOIL SAMPLING & RESULTS

YBDEMUR ppm. • SAMPLE NO.


10. *Leucosia* *leucostoma* *leucostoma* *leucostoma* *leucostoma*

Page No.	10	Map Name	1:250,000	Prepared by	ERP
		Geological Map No.		Prepared by	GM
25		Scale	6" to 1 mile	Date	DECEMBER, 1977
V		MAP LINES; GATE, NAVIGATE			
		MAP LINES; GATE, NAVIGATE			



Consolidated Gold Fields Ltd.

SCOTTISH EXPLORATION

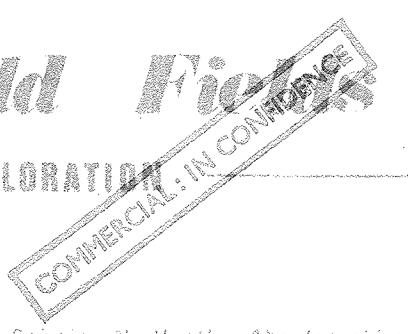

Field Office: 'Little Dough', Ruthven, Cairnie, Nr Huntly, Aberdeenshire

Number Sequence: ppm Copper / ppm Tin
ppm Molybdenum / ppm Tungsten
Sample Numbers LSI-399 & LS 671-675


NE3/24

Scale 1 inch to 1 mile

Date 10th June 1971

Drawn C.P.R.

Overlay to be read with O.S. Sheet No. 61.

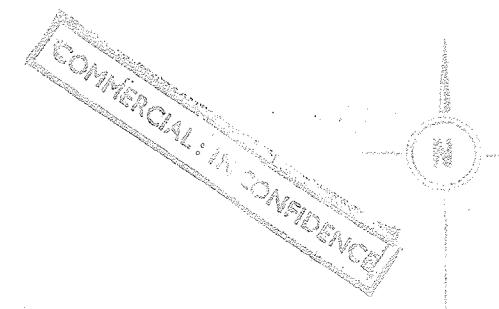

Consolidated Gold Fields Ltd.

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Area: LAKE DISTRICT: COCKERMOUTH

TITLE: TORPENHOW ANOMALY - DETAILED I.P.
RESISTIVITY - CHA - n

POLAR - DIPOLE $N=2$ $\zeta=100^{-1}$ AE3/23

Drawing No. O.S. Map No. CUMBERLAND XXXV/15 XXXVI/3
Scale: 25' to 1 MILE Prepared by ERP
Date Oct 1972 Drawn by JK
Revision No. Lines extended to south Dec 1972

Consolidated Gold Fields Ltd.

Project:

Area: LAKE DISTRICT - COCKERMOUTH

Title: TORPENHOW ANOMALY - DETAILED

CHARGEABILITY - M. SECS.

DIPOLIE - DIPOLE $N=2$ ($\approx 100^{\circ}$) ~~100-300~~

Drawing No. O.S. Map No CUMBERLAND XXXVI 15 XLVII 3
XXXVI 16 XLVII 4
Scale 25 "to 1 mile Prepared by E.R.P.
Date OCT 1972 Drawn by J.R.
This extended to south Dec. 1972
RECORDED

WATER LEVEL IN FEET) ABOVE SEA LEVEL

10. *U.S. News & World Report*, 2013 Best Graduate Schools, www.usnews.com/best-graduate-schools.

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Zinc (Zelzinc)


AE312

Document 3

CS 51: What Does Computer Science Mean? 2

1000 1000 1000

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ELEVATION FEET ABOVE SEA LEVEL

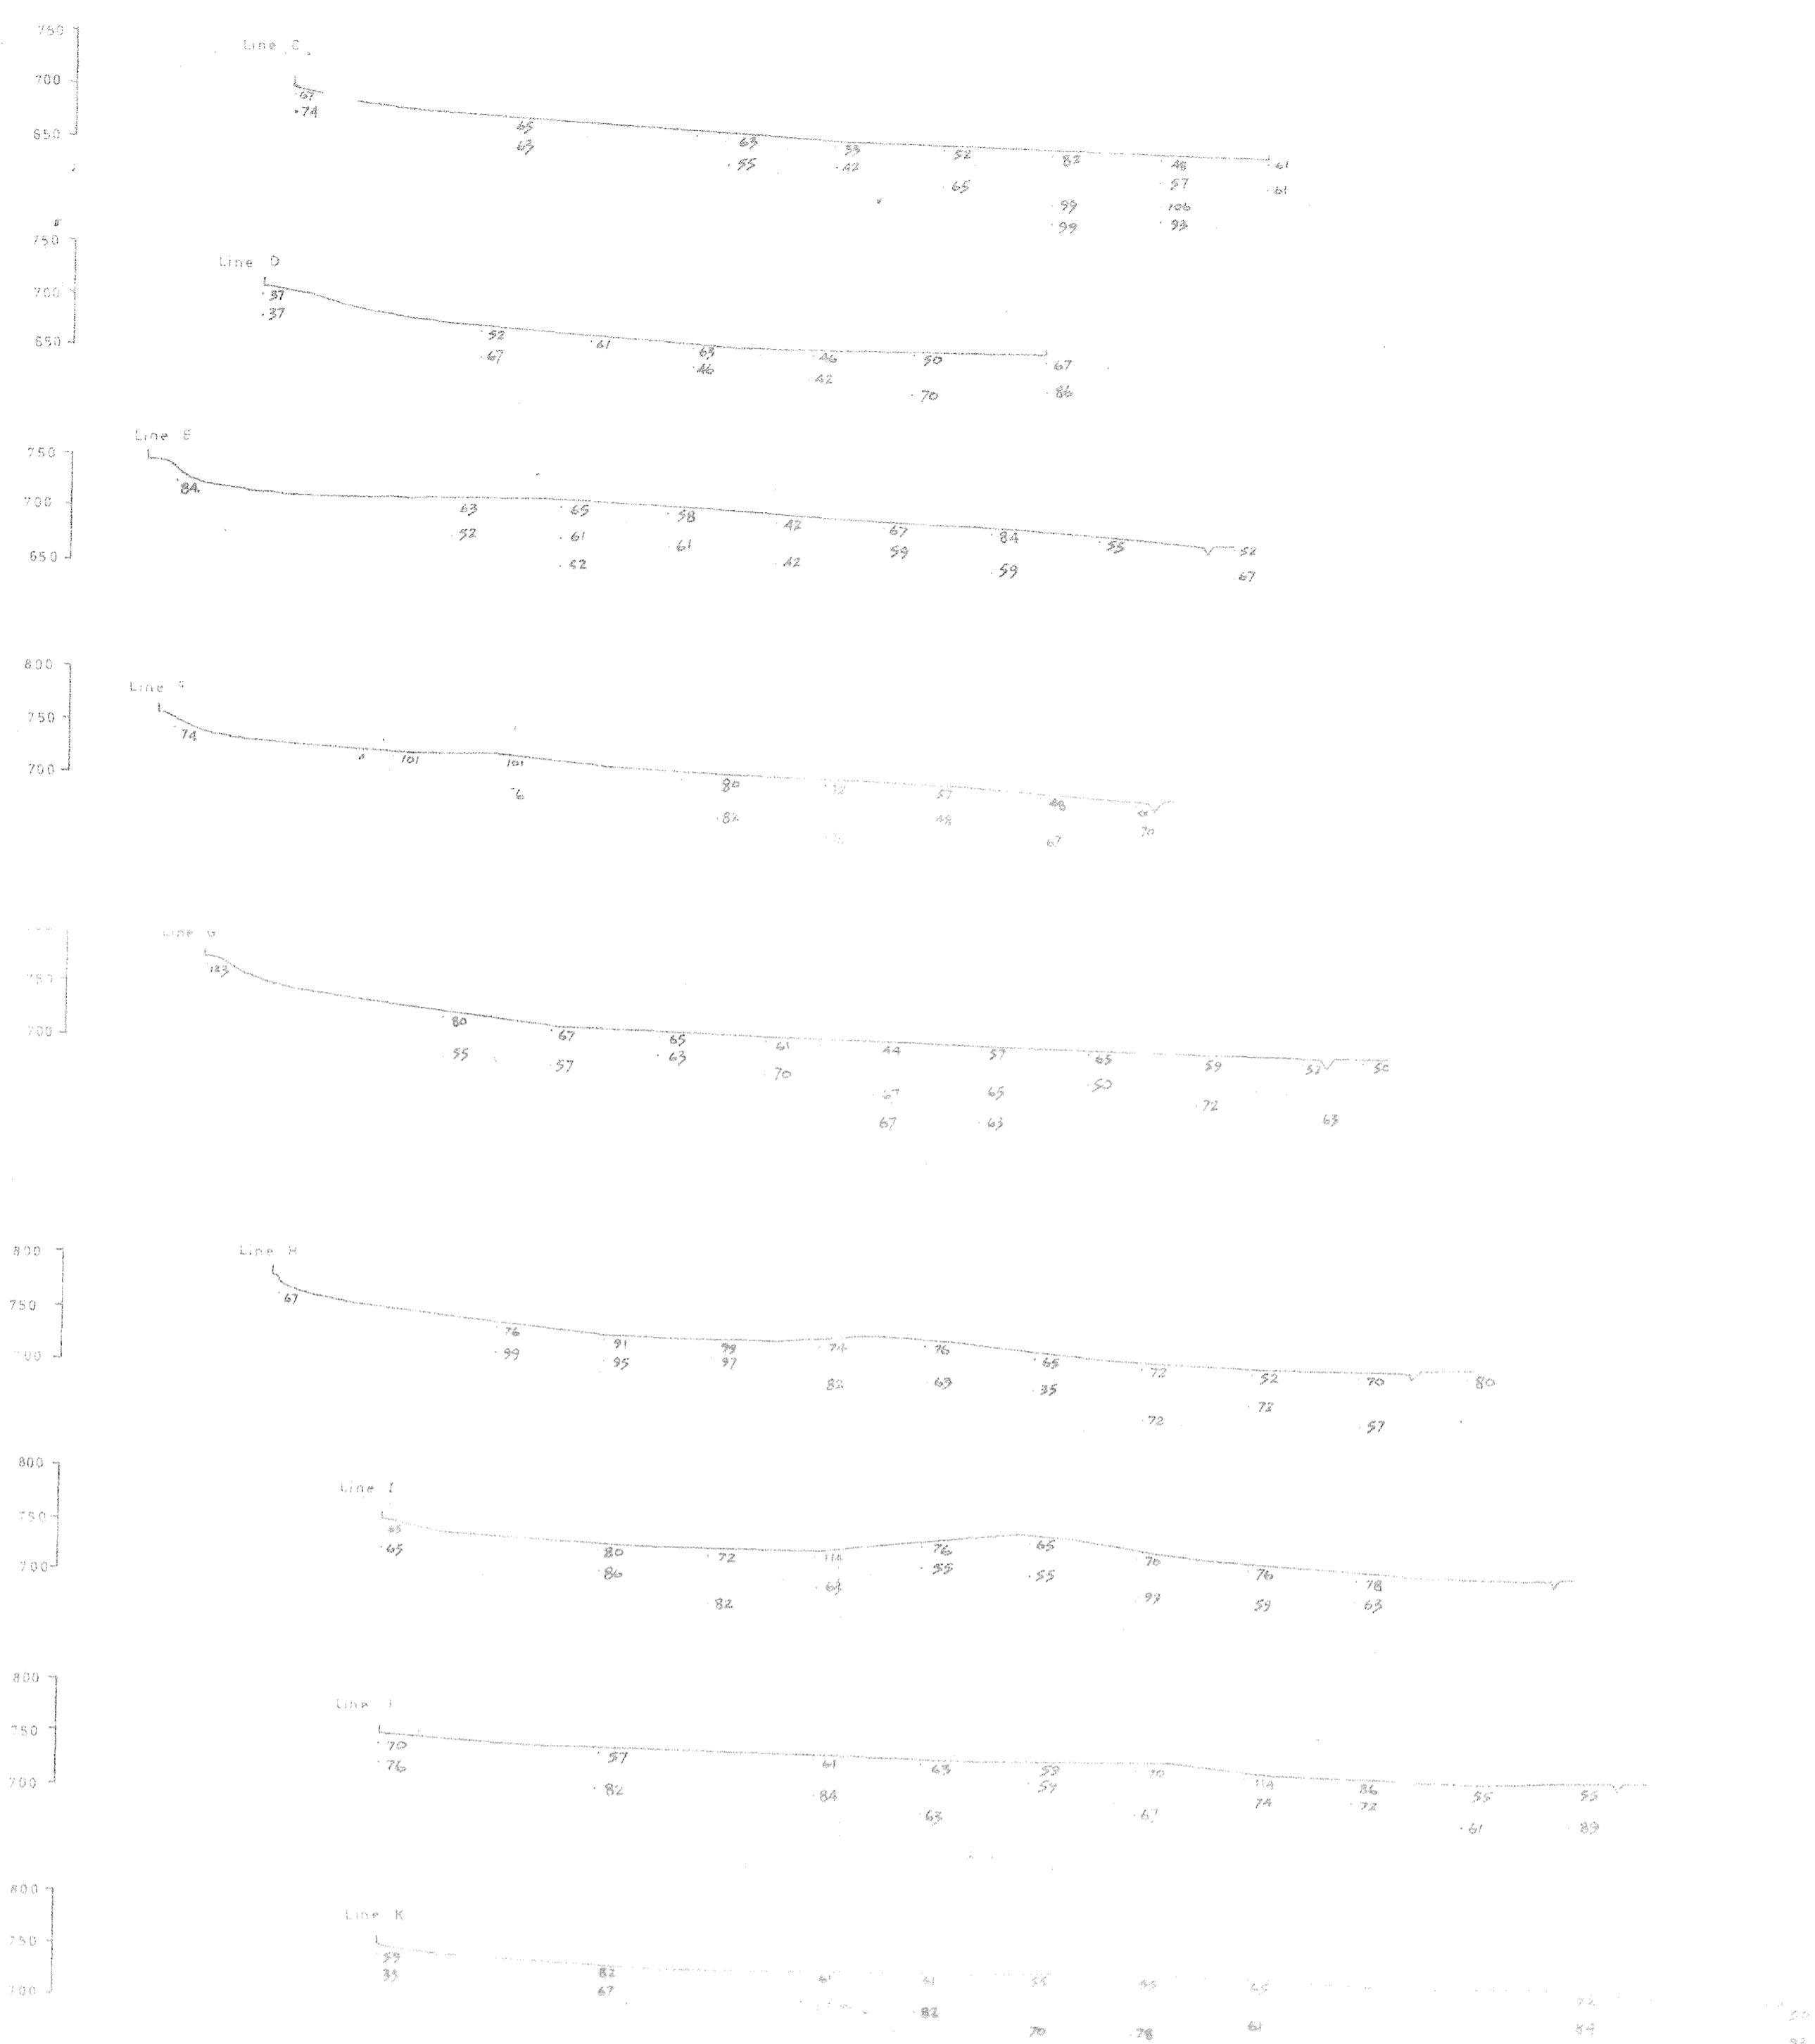Consolidated Gold Fields Ltd.

EXPLORATION

Project: LAKE DISTRICT - COCKERMOUTH

Area: Torpenhow Anomaly

Title: SECTION -- Lines C - K

Lead (Pb) p.p.m.

AE3 | 20

Drawing No.	O.S. Map No. Cumberland XVI 3
Scale: 2cm = 100'	Prepared by: E.R.P.
Date: Oct. 1972	Drawn by: A.T.W.
Revisions:	



Consolidated Gold Fields Ltd.
SCOTTISH EXPLORATION


Number Sequence ppm Copper ppm Tin
ppm Molybdenum ppm Tungsten
Sample Numbers LS 401 - 669

Scale: 1 inch to 1 mile

Date 9th June 1971

Drawn C.P.R.

AESII

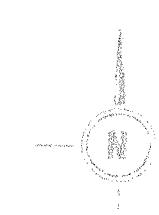

Overlay to be read with B & Sheet No 90.



Consolidated Gold Fields Ltd.

EXPLORATION

LAKE DISTRICT


Cockerham - Torpenhow Area

PIT PROFILES AND GEOCHEMICAL PROFILES

AE3|17

17

Line No.	NV 13 NE NY 23 NW	Prepared by G.L.P.
Geographical Map No.	ATW.	
Scale 6" = 1 mile	Date 30 May 1972	
Revisions		

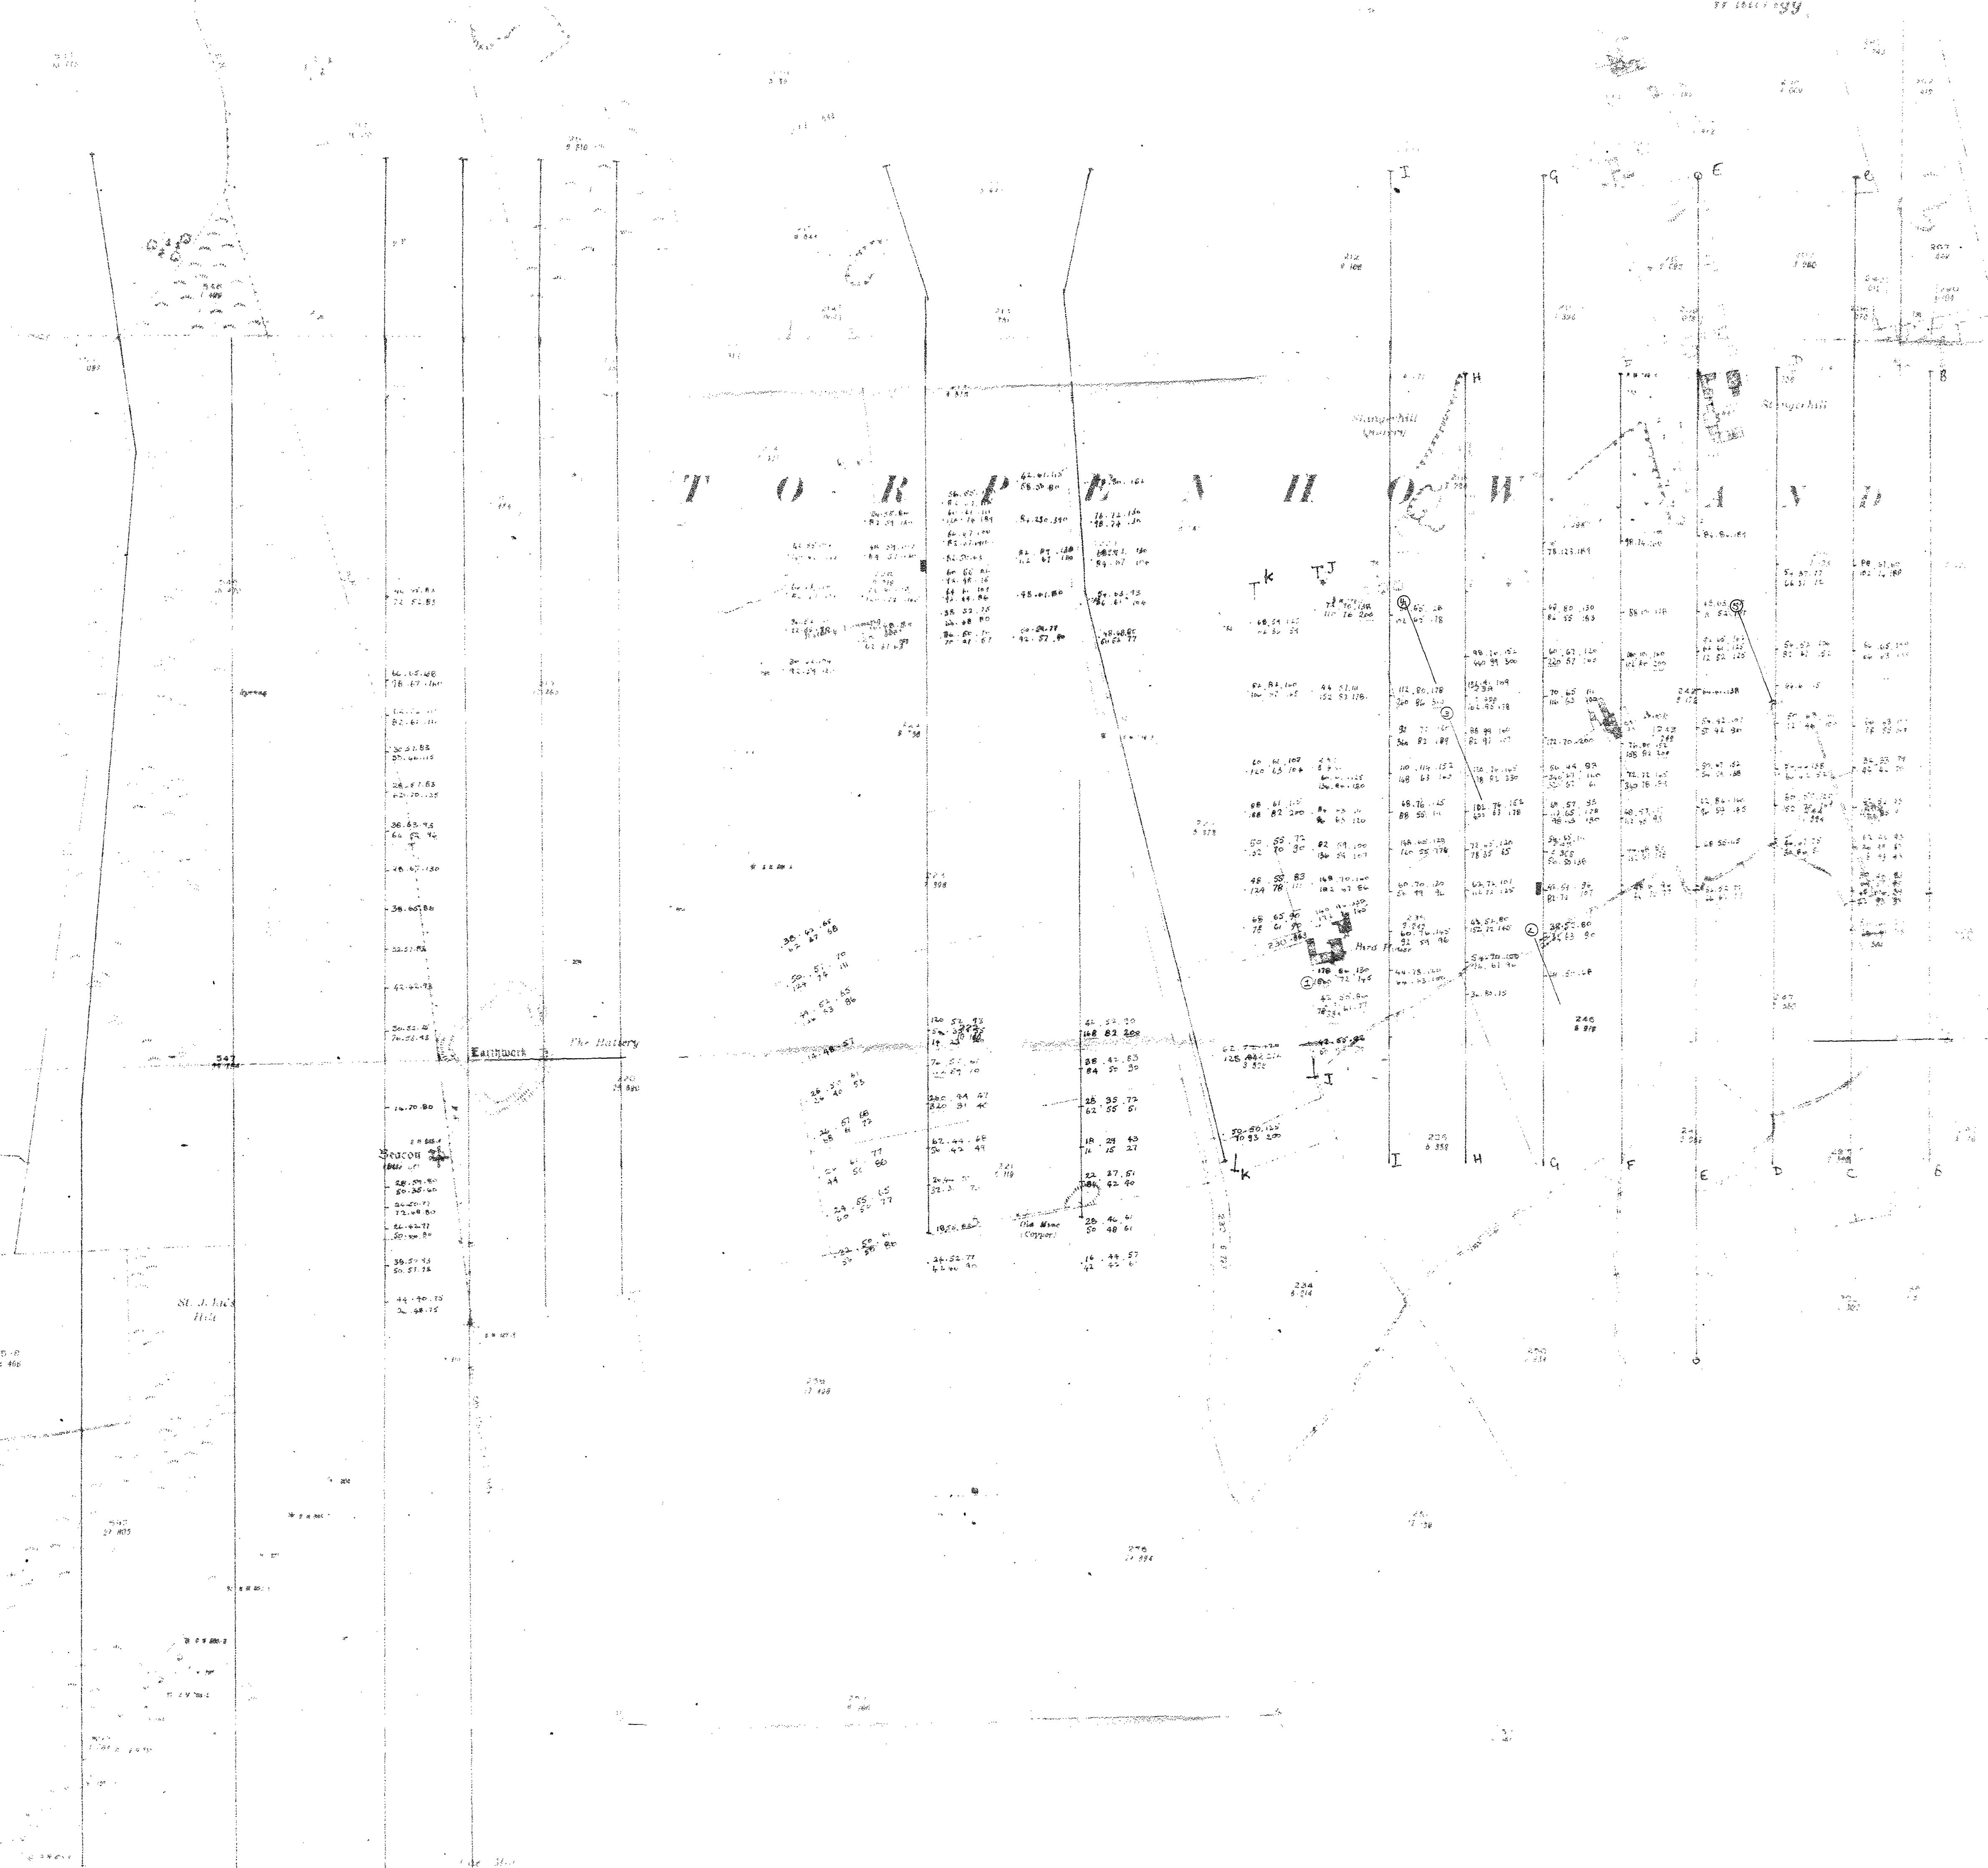

Consolidated Gold Fields Ltd.

EXPLORATION

Product Cu, Ni, Mo

Area: LAKE DISTRICT - COCKER MOUTH

Title: TORPEYNHOW ANOMALY

DETAILED SOIL PROFILE SAMPLING

- Cu, Pb, Zn TOP SAMPLE
- Cu Pb Zn BOTTOM SAMPLE

AE3/18

Dipperhead Hill	12 ~ step No. Cumber end X X X V I 12 X LVI 3,	X X X V I 12 X LVI 4,
	25° 10' NNE	Elevation 1100 ft
	Oct 1972	Mineral 2 TSW

NORTH LAKE DISTRICT

COCKERMOUTH AREA - PART OF AES MOLY STUDY

CONSOLIDATED GOLD FIELDS LTD.

SCOTTISH EXPLORATION

AE3

Field Office: "Little Dough" Ruthven, N. Huntly, Aberdeenshire.

Samples BRI6 to BRI79

Number Sequence Copper Zinc x10

$$\text{eq } \frac{3.5}{3} 60 = \frac{35\text{ppm Cu}}{30\text{ppm Pb}} 600\text{ppm Zn}$$

NY13		NY 2
------	--	------

O.S. Sheets on this overlay

Scale: 2½ inches to 1 mile

Date: 21st. May 1971

Drawn: C.P.R.

Overlay to be read with O.S. Sheet No. NY13 & 23



Constituted Gold Fields Ltd.

XIV. THE CLOTHES

COCKE & MOUTH AREA

LAKE DISTRICT - TORPENHOW


Section No. 3 Gas System

Solid grid

Sample numbers: Lg 1-270
Lg 1080-1550.

AE3 | 12

One	NY 13 NE, 23 NW	Prepared by G.L.P.
12	Topographic Map No. 1	B.P.
	Scale 6" to 1 mile	April 2

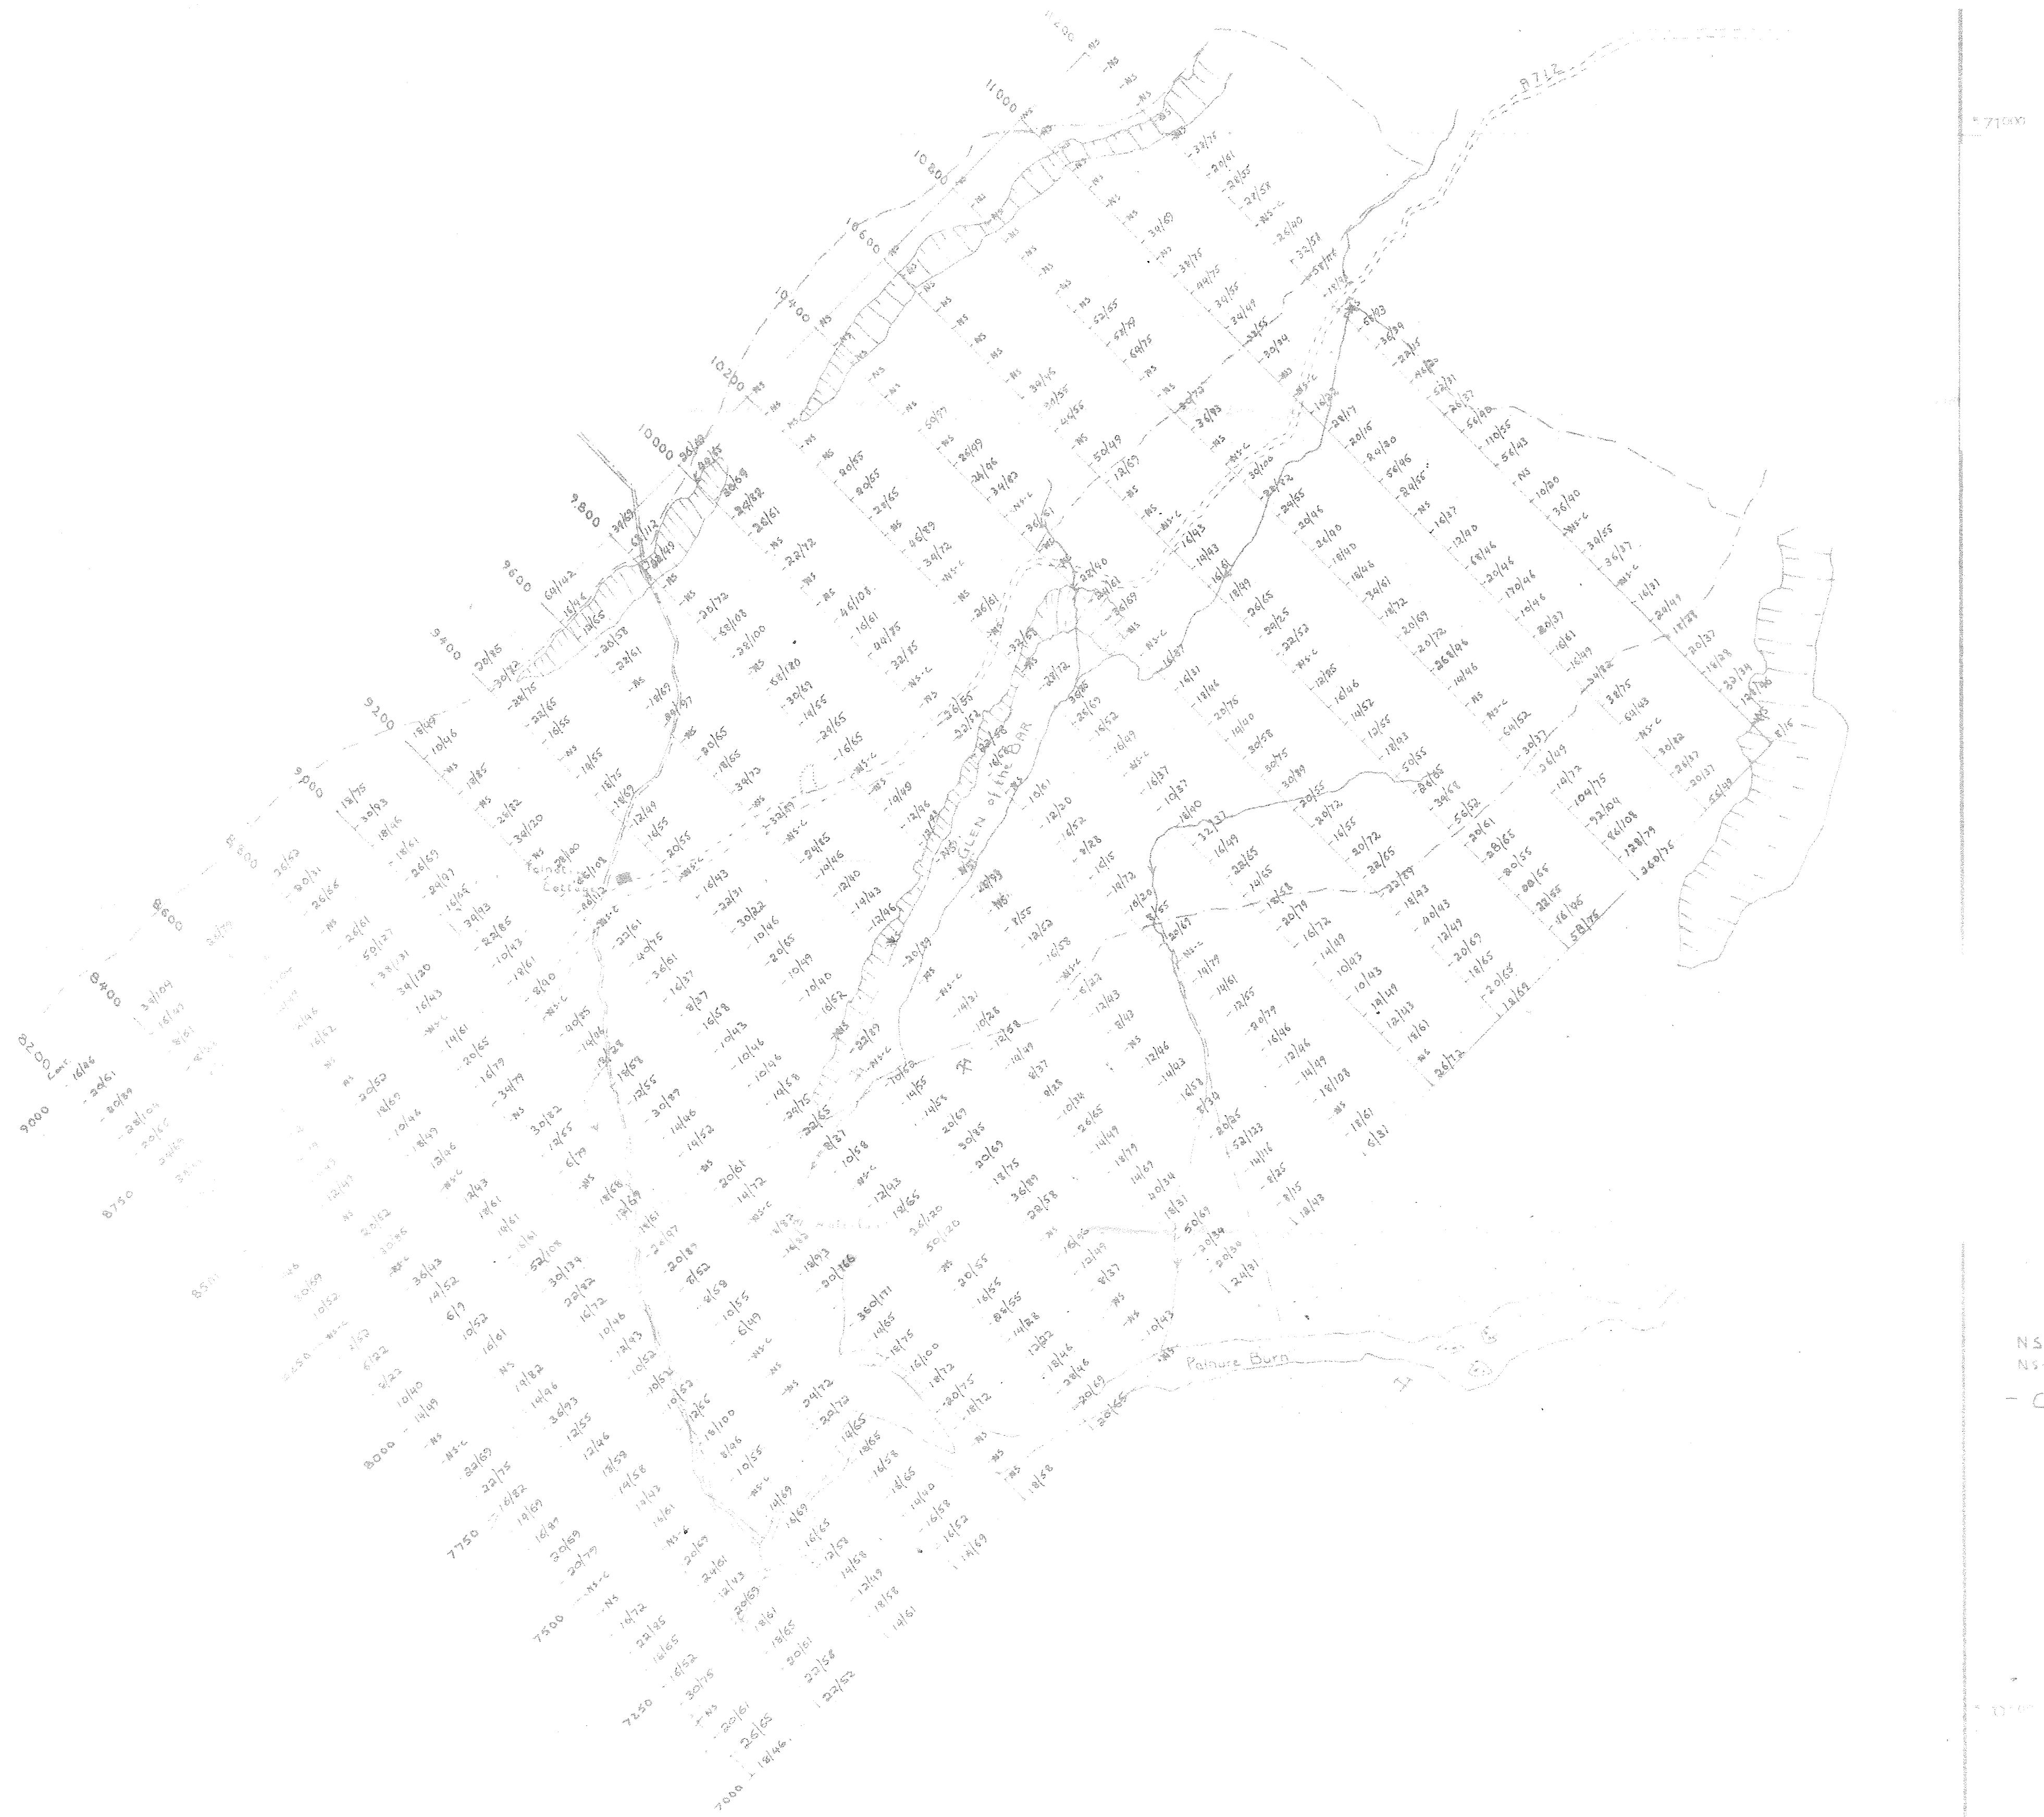


DETIL SOIL SAMPLING

NS - No Sample
NS C - Control
- Cu - Ni in ppm

OS MAP No. 1:250,000
SCALE 1:250,000
DATE 20/05/97
DRAWN BY G.P.
CHECKED BY G.P.

AE3/9

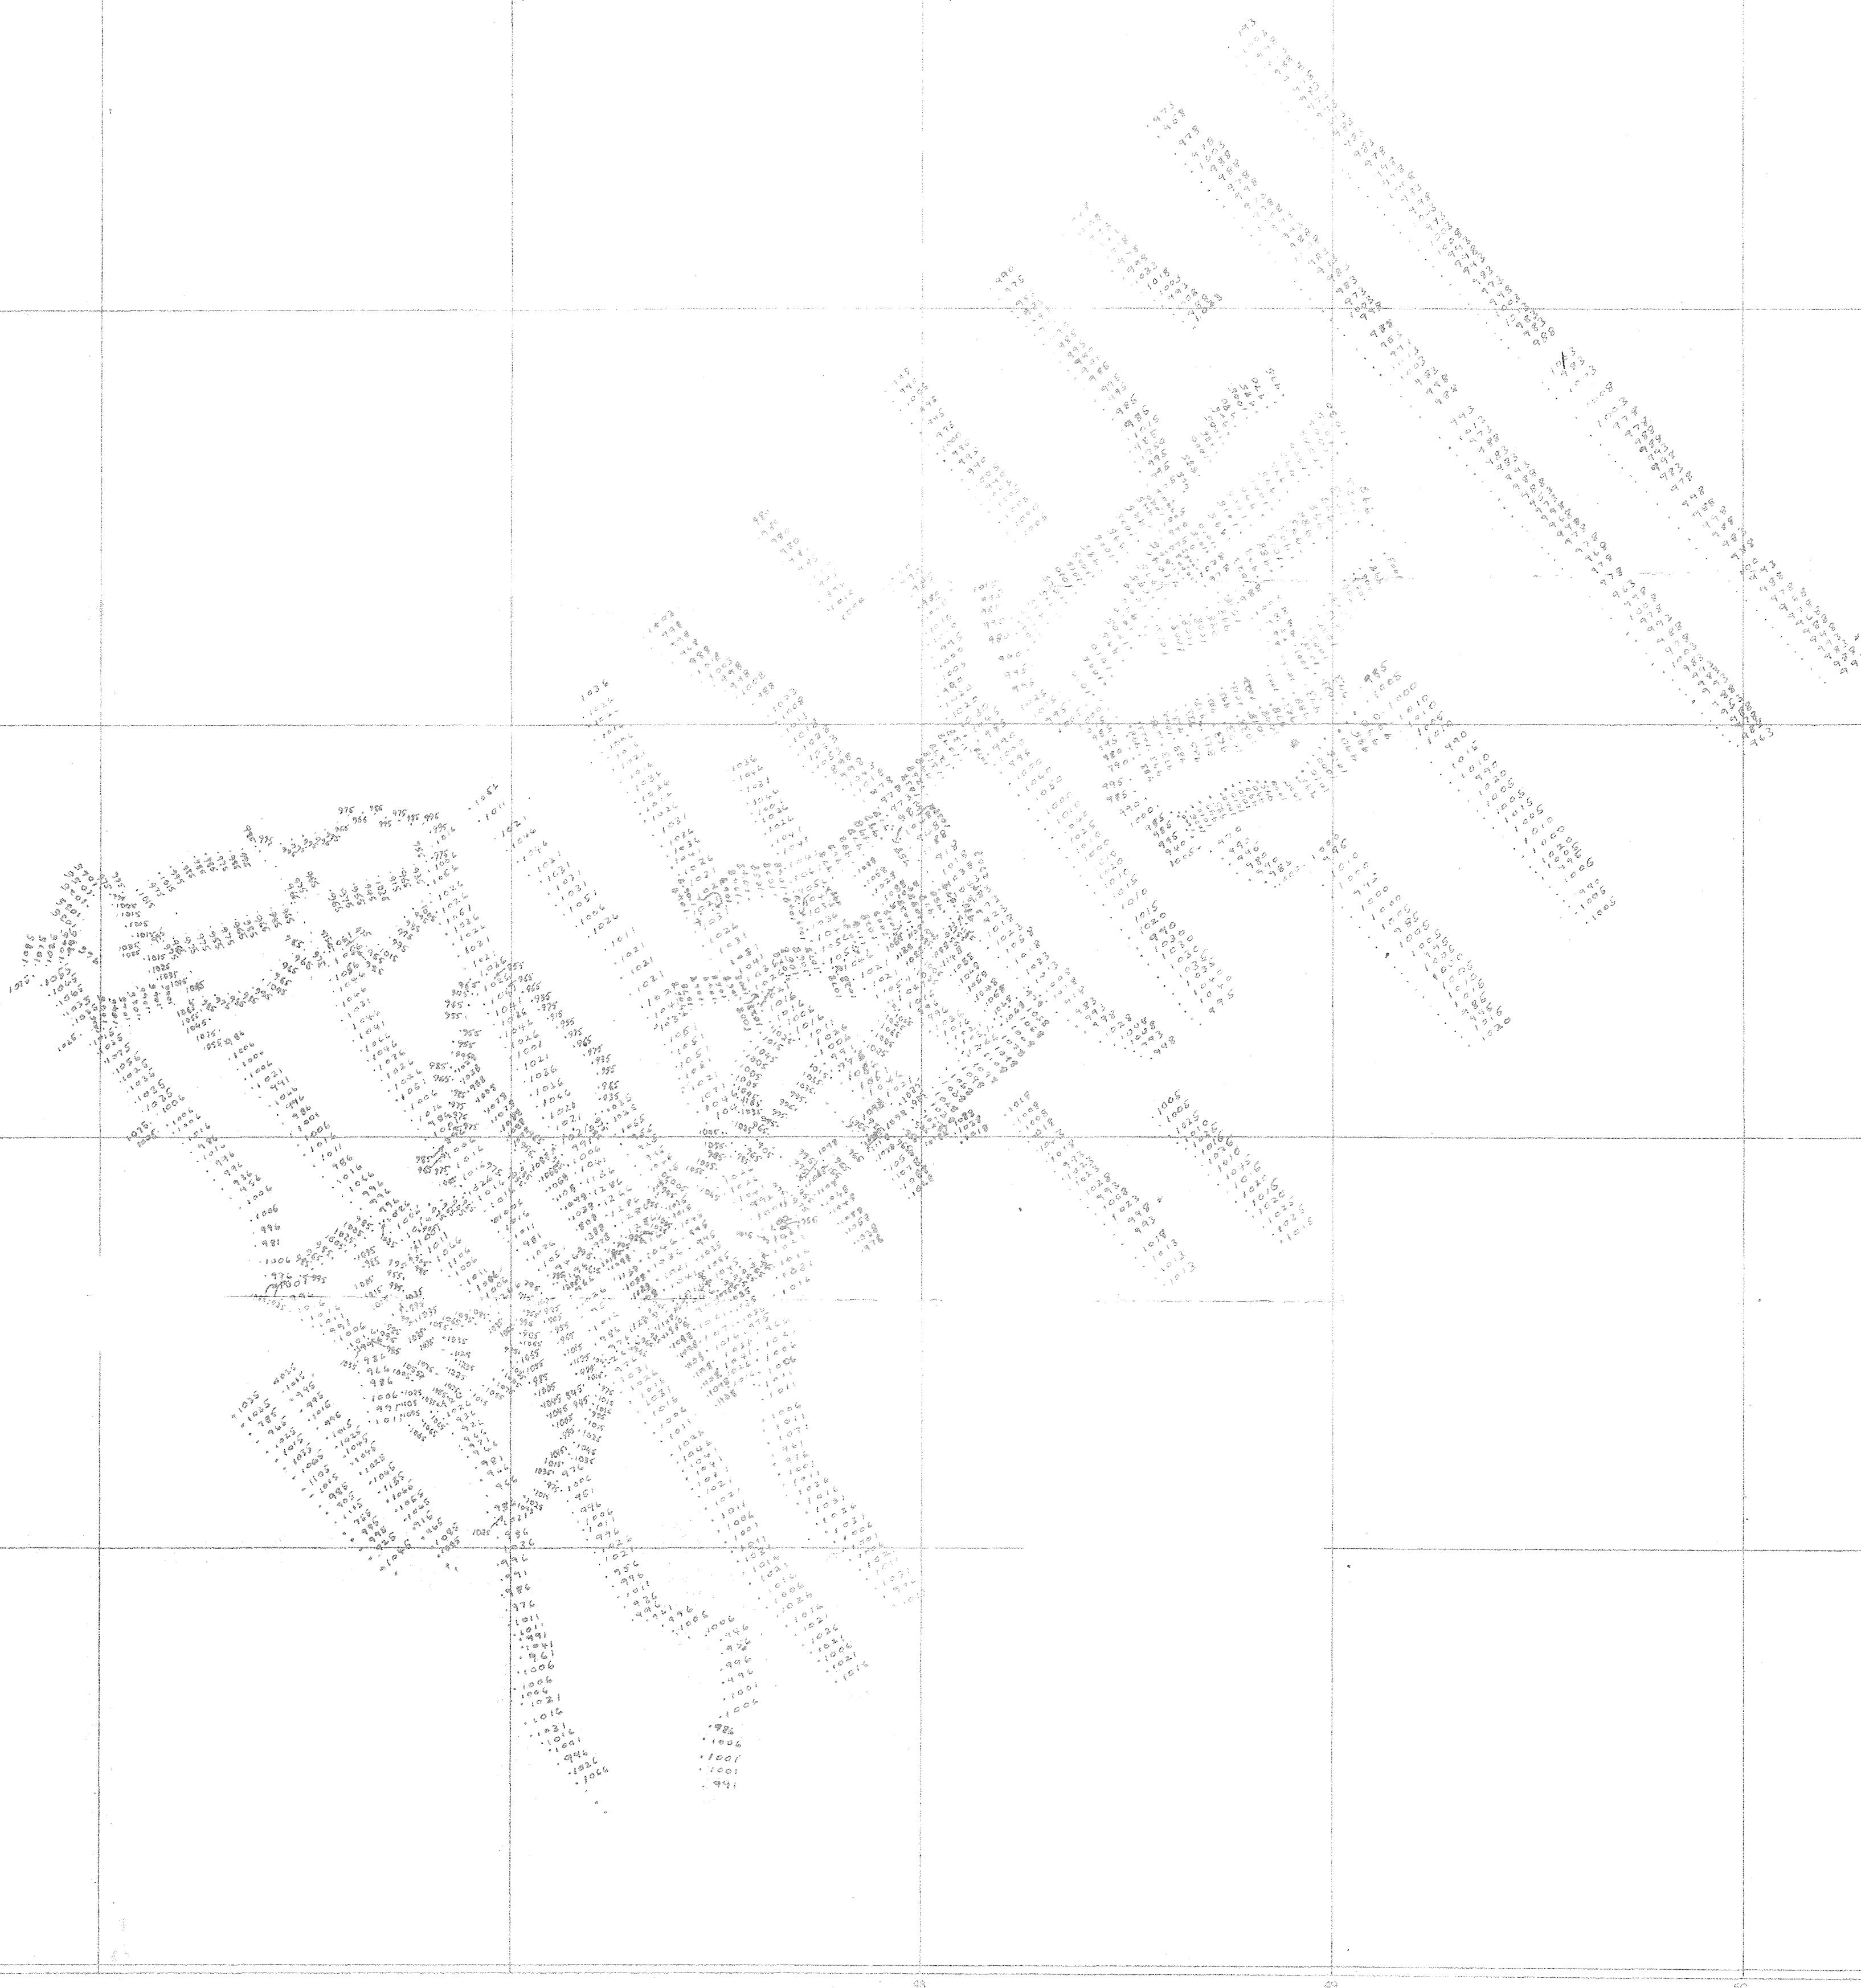

Consolidated Gold Fields Ltd.
SCOTTISH EXPLORATION

Title:


TALNOTRY - MAGNETOMETRY


VERTICAL MAGNETIC INTENSITY IN GAMMAS

AE3(B)

+ LOCAL ARBITRARY BASE

Drg. No.	O.S. MAP NO. NX47SE, NX57SW, NX46NE	Prepared by G.L.P.
Geological Map No.	Drawn by B.P.G.C.	
Scale 6" to 1 mile	Date Jan 21 1972	
Revisions		

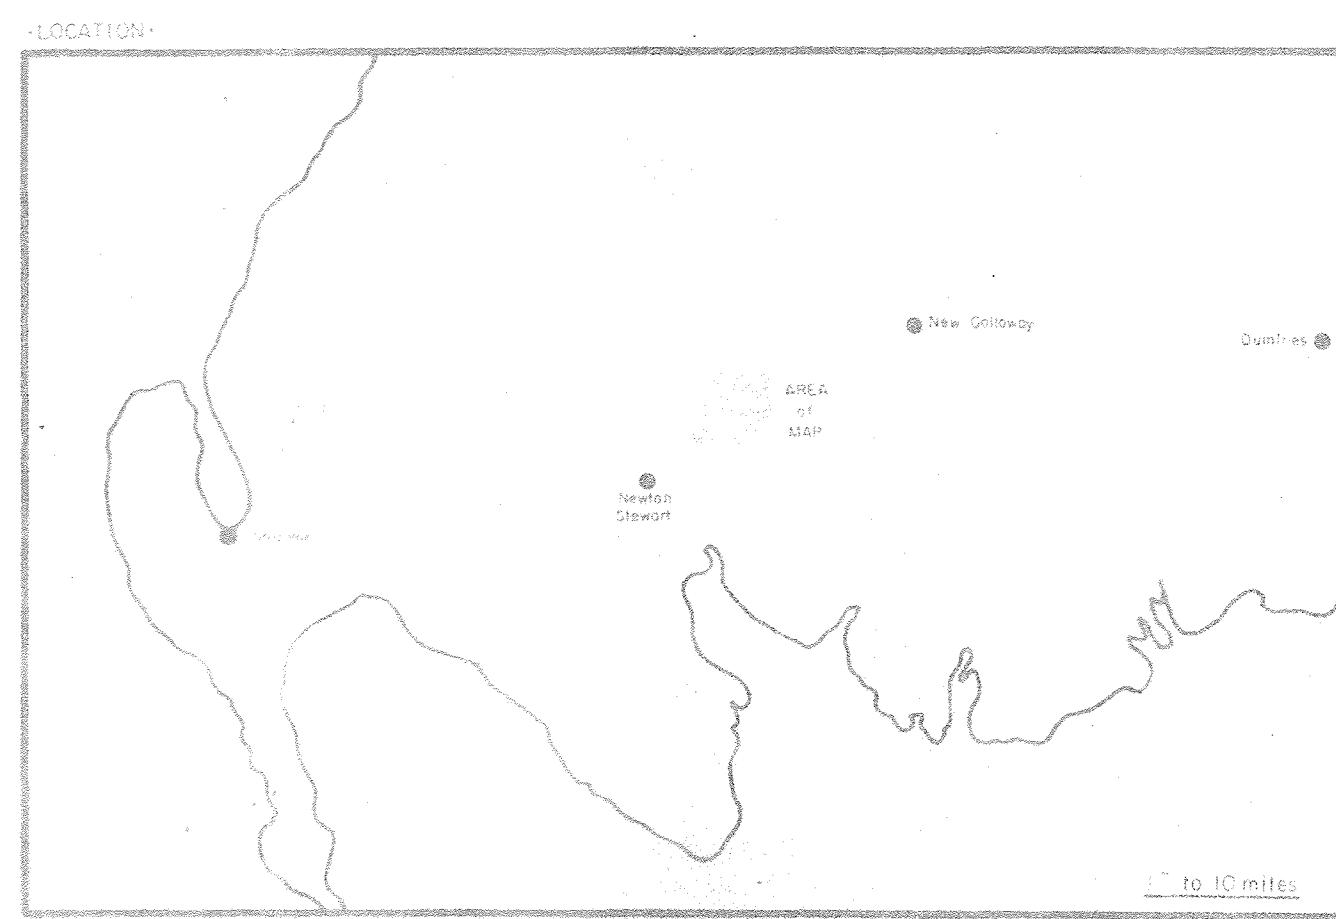

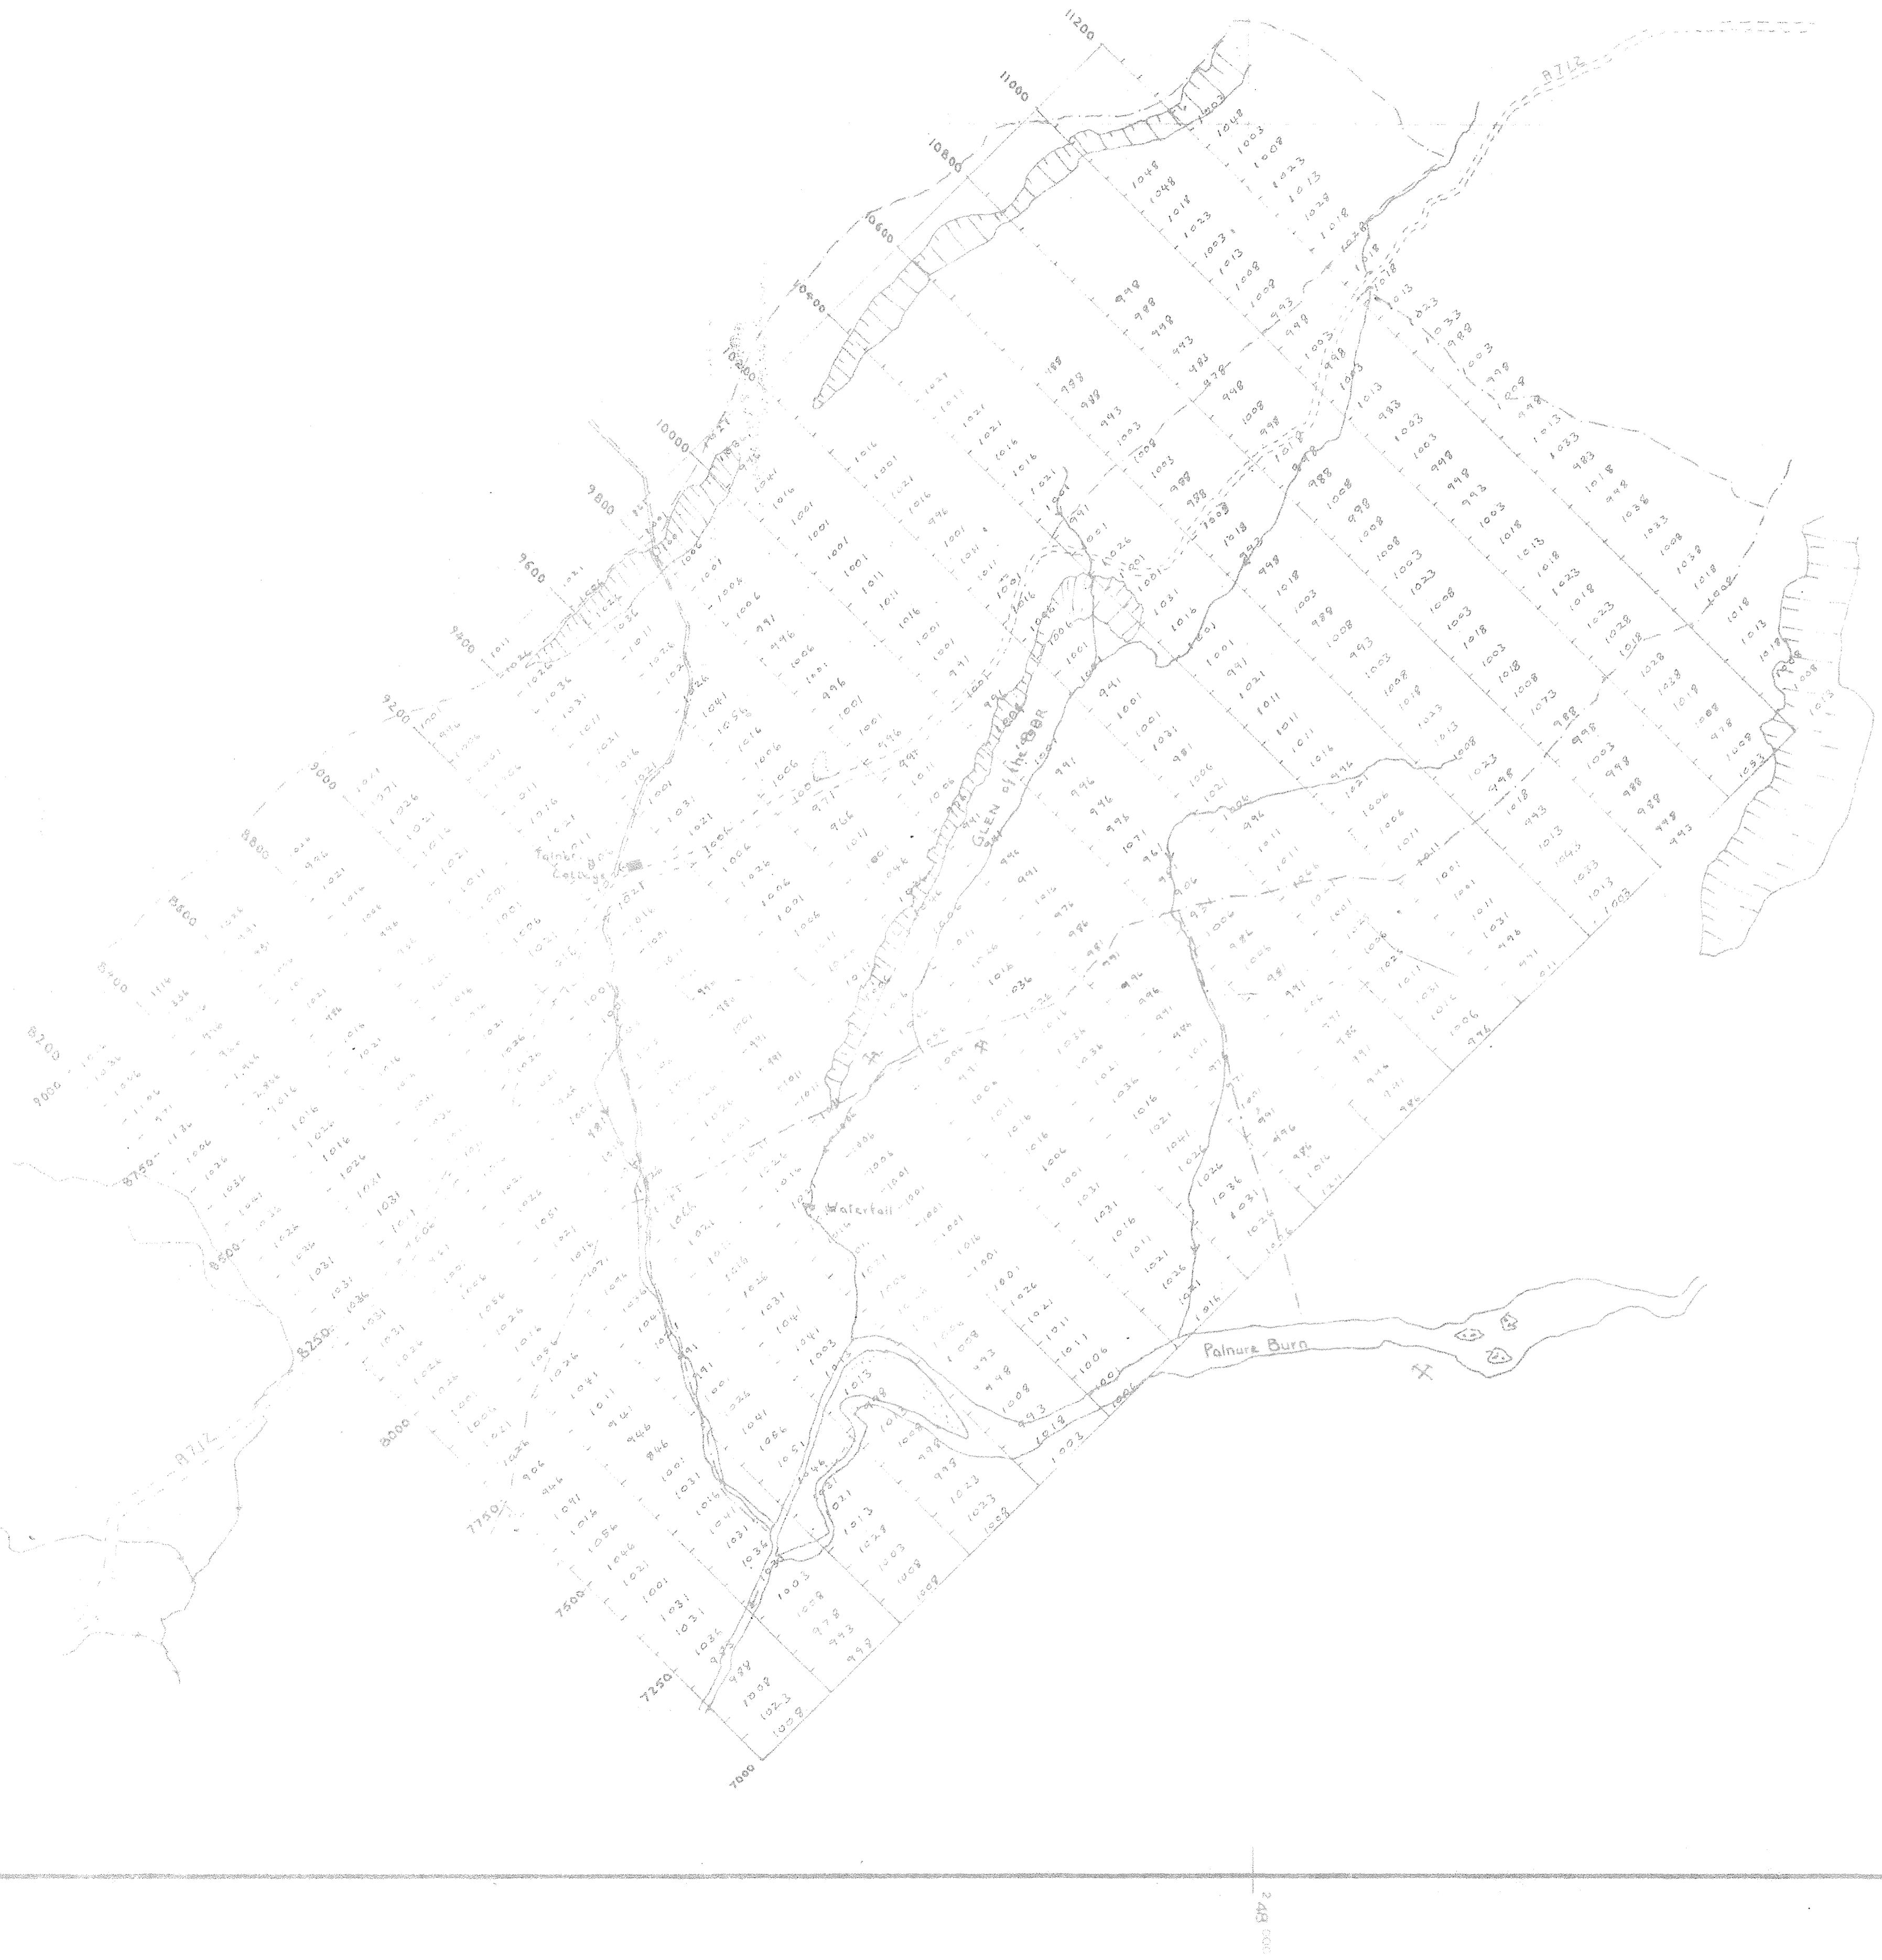

TALMOTRY BASE PLAN

DETAIL MAGNETOMETRY

VERTICAL MAGNETIC INTENSITY IN GAMMAS[†]

LOCAL ARBITRARY BASE

OS MAP NO 5 MILE X 7 1/2 MILE 55X10/9

1:25000

4th Feb

AE3
10

570 000

490 000

410 000

330 000

250 000

170 000

90 000

10 000

1000

100

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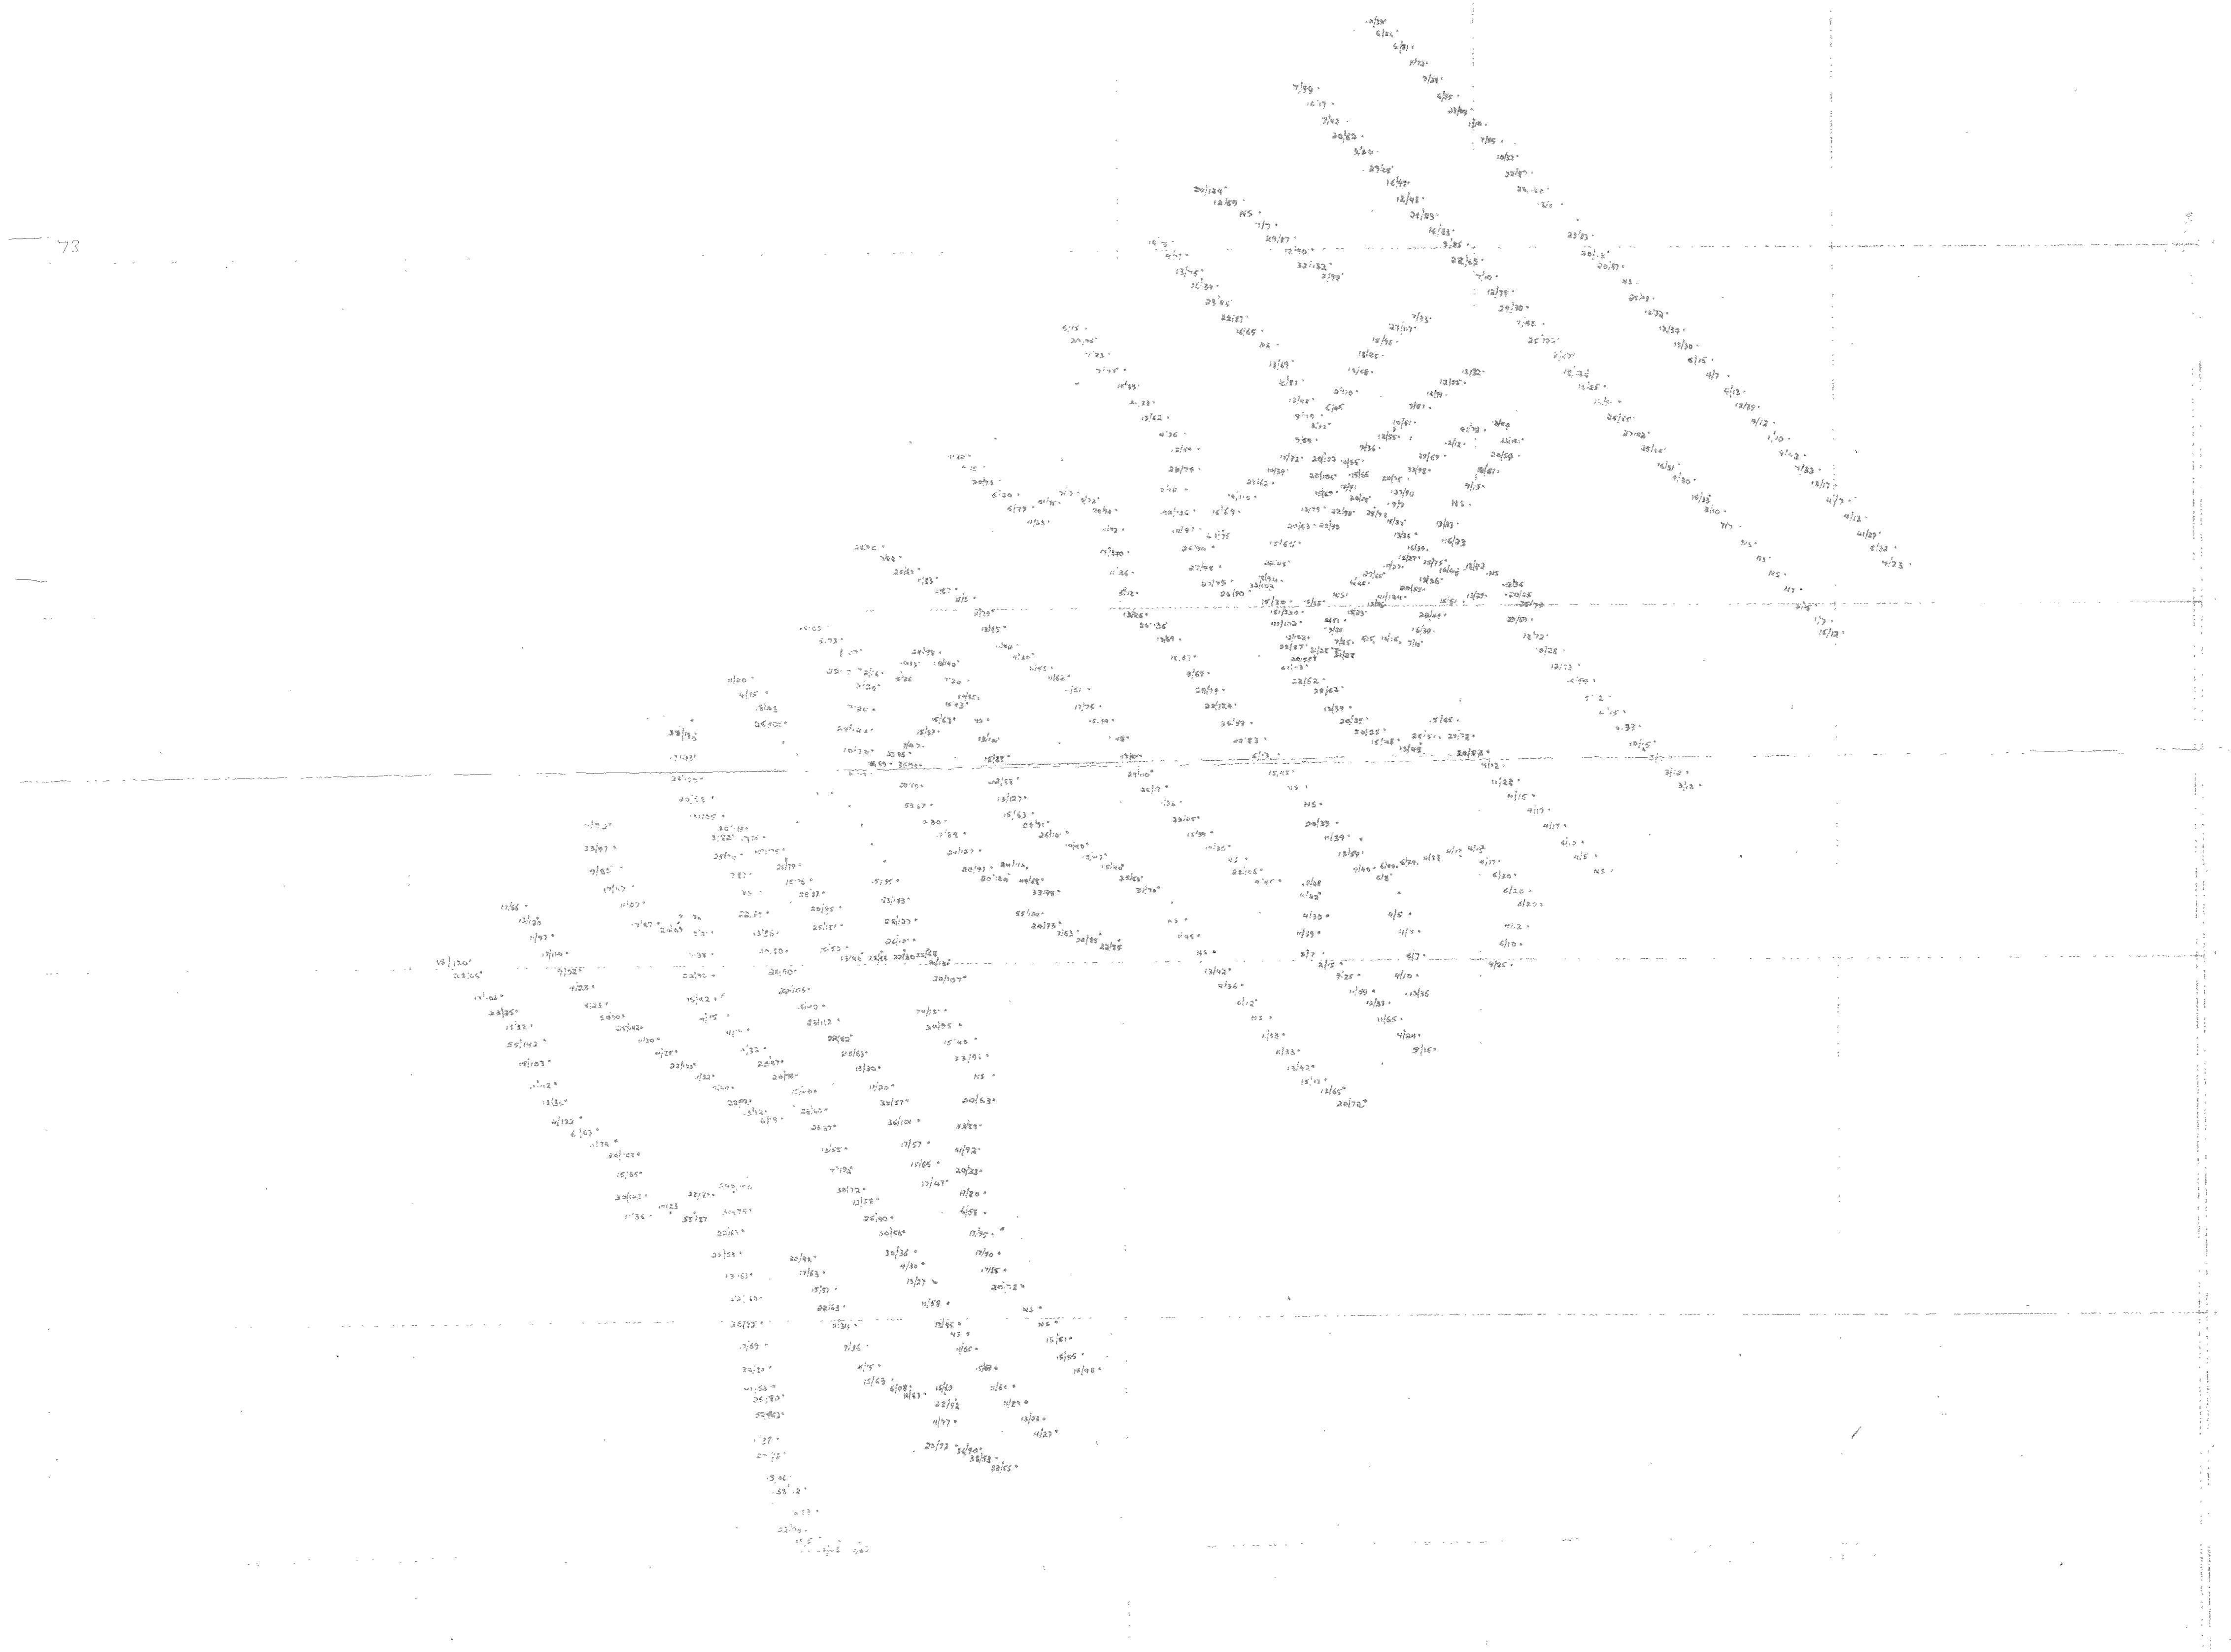
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73



Consolidated Gold Fields Ltd.

SCOTTISH EXPLORATION

TALNOTRY AREA
RECCES SOIL SAMPLING - LC

Values in ppm
Cu / Ni ✓

AESh

NY 47 SE
57 SW
06 NE
String of Map No 4 & B

Prepared by G.L.P.


G.L.P.

7

Scale 6 inch = 1 mile

Dated 6th April 1972

Remarks

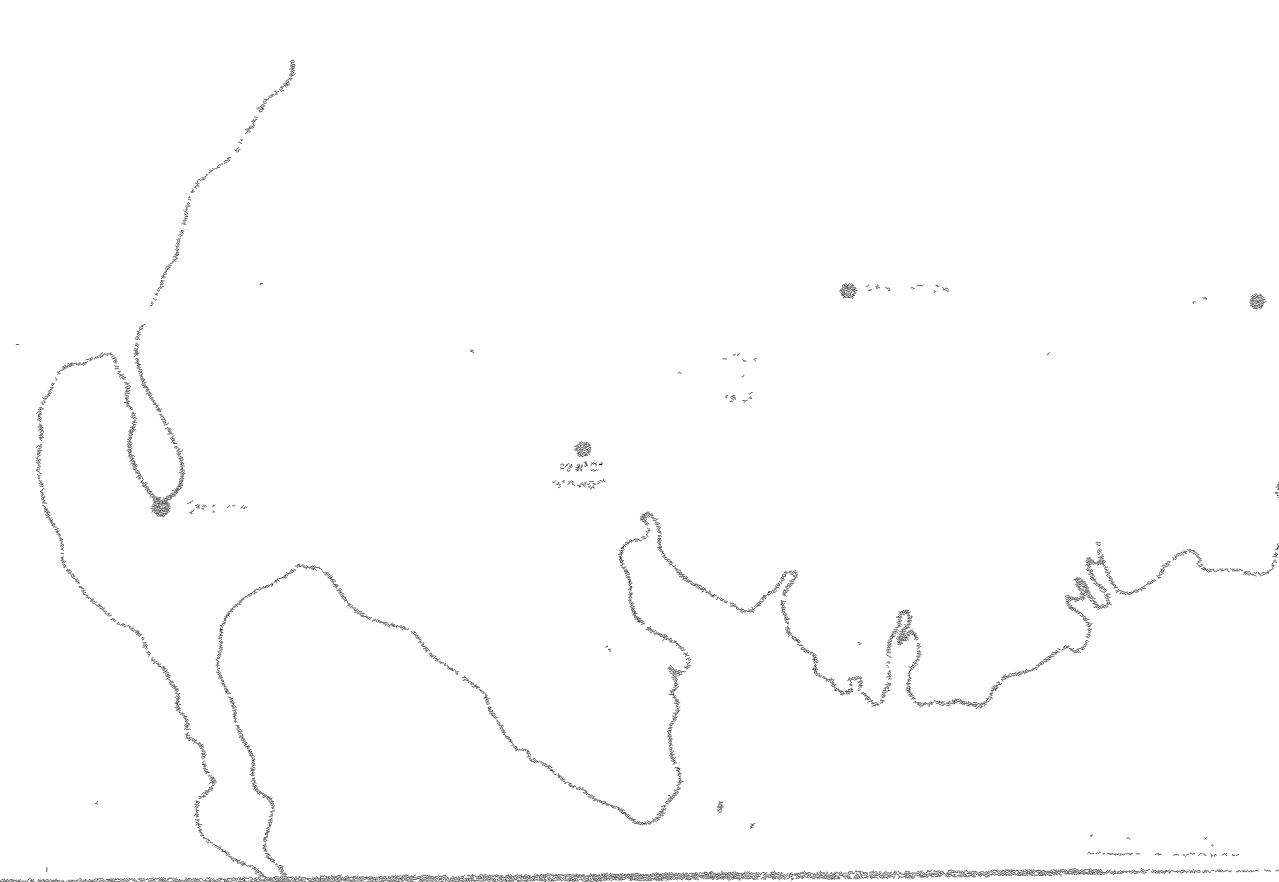



Consolidated Gold Fields Limited		DRG. No.
Area: TALNOTRY Mo AREAS ✓		
Title: CRAIGLOWRIE HILL		
SOIL SAMPLING RESULTS • Cu/Mo PPM		
AE3/6		
O.S. Map No. NX 56 NW, NE		
Scale: 6" to 1 mile	Date: AUGUST 1972	
Prepared by: ERP	Drawn by: ATW	

8 Areas sampled after June 1973 1972 — checked with M.F. Jones
+ CBF on 8.7.74

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Consolidated Gold Fields Ltd.

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Timothy Ho Flora

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Son, Sonnenschein, Wohl Ich

Arztk

EXPLORATION

TOLKOTAY Ma. RIVER

Loc. Ken

San Francisco 44 mi N


AE35

H.R. 67 SW

1

1900

1901

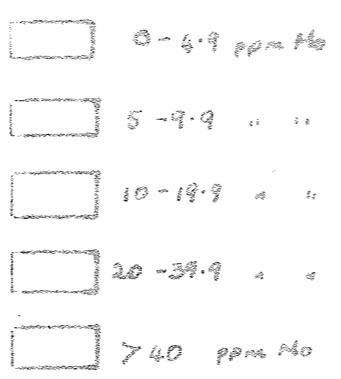

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TALNOTRY Mo AREAS

1. *L* *f* *f* *L* *L* *f* *f* *L* *L* *f* *f* *L* *L* *f* *f* *L* *L* *f* *f*

MOLYBDENUM ppm.

So., Samipiso. 22. 1883.

180

1 - 4 2 ppm Mo

2 - 9 2 ppm Mo

3 - 19 2 ppm Mo

>20 ppm Mo

1 2 3 100

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COMMERCIAL: IN CONFIDENCE